




NOTE

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PROJECT.



Smith + Andersen

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PROJECT

PROJECT ADDRESS

17250 YONGE STREET, NEWMARKET, ONTARIO L3Y 4W5

TITLE

PROJECT NO.	DRAWN	CHECKED
14008-025-E	JB	WYC/NC

DRAWING NO.	SCALE
11-01	N.T.S.


SCALE
N.T.S.

8
TE-0.1

6 POWER LEGEND 1 OF 2
TE-0.1

4 LIGHTING LEGEND 1 OF 2
TE-0.1

2
TE-0.1 FIRE ALARM LEGEND 1 OF 2

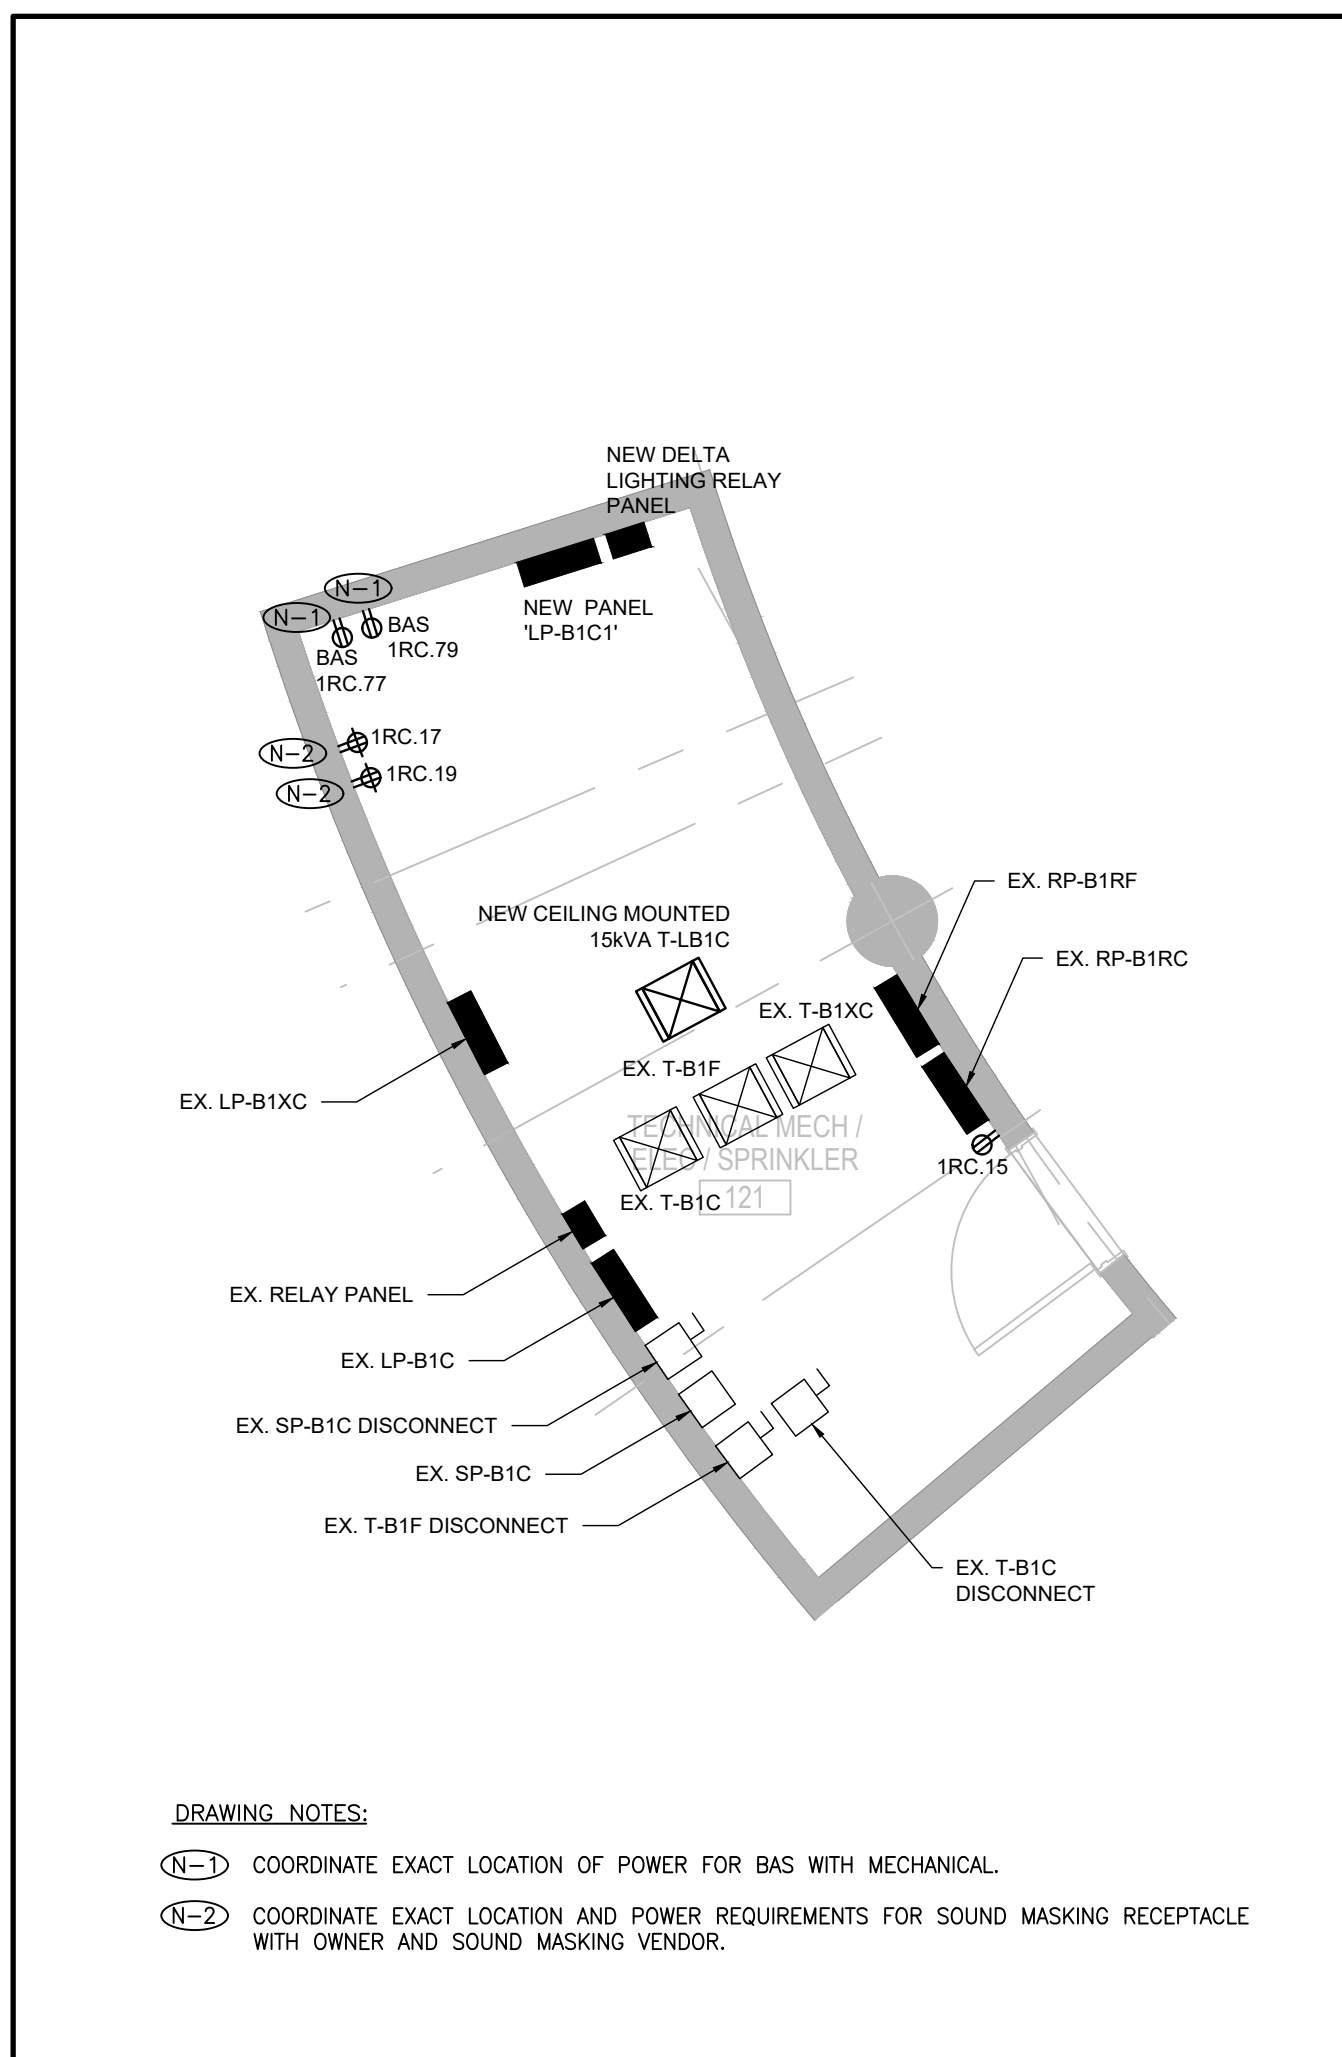



















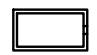

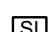


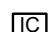

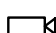

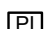
6 ELECTRICAL ROOM 121 DETAIL

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5 GENERAL AND SYMBOLS AND ABBREVIATIONS


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3 DATA AND COMMUNICATIONS

SYMBOL		DESCRIPTION	
ELECTRONIC PERSONAL PROTECTION			
	EMERGENCY PHONE STATION		DURESS ALARM STATION
	STROBE LIGHT		PANIC ALARM RECEIVER
	PANIC BUTTON		ASSISTANCE REQUIRED SIGN
INTERCOM LEGEND			
	INTERCOM		MASTER INTERCOM
	ENTRY PHONE CONSOLE		
VIDEO SURVEILLANCE			
	FIXED CAMERA		VIDEO SURVEILLANCE SYSTEM SERVER
	PAN-TILT-ZOOM CAMERA		POWER INJECTOR
	PERSONAL COMPUTER		VIDEO MONITOR
	COMPUTER MONITOR		FIXED VIDEO SURVEILLANCE CAMERA HORIZONTAL ANGLE OF VIEW
	DIGITAL VIDEO RECORDER		LCD MONITOR, SIZE AS INDICATED
	NETWORK VIDEO RECORDER		
INTRUSION DETECTION			
	SIREN		INTRUSION DETECTION SYSTEM PANEL
	BREAK GLASS SENSOR		POWER SUPPLY
	MOISTURE SENSOR		WALL MOUNTED SECURITY MOTION SENSOR
	KEYPAD		CEILING MOUNTED SECURITY 360° MOTION SENSOR

NOTE: NOT ALL SYMBOLS APPLY, REFER TO FLOOR PLANS AND DRAWINGS

1 SECURITY LEGEND 2 OF 2

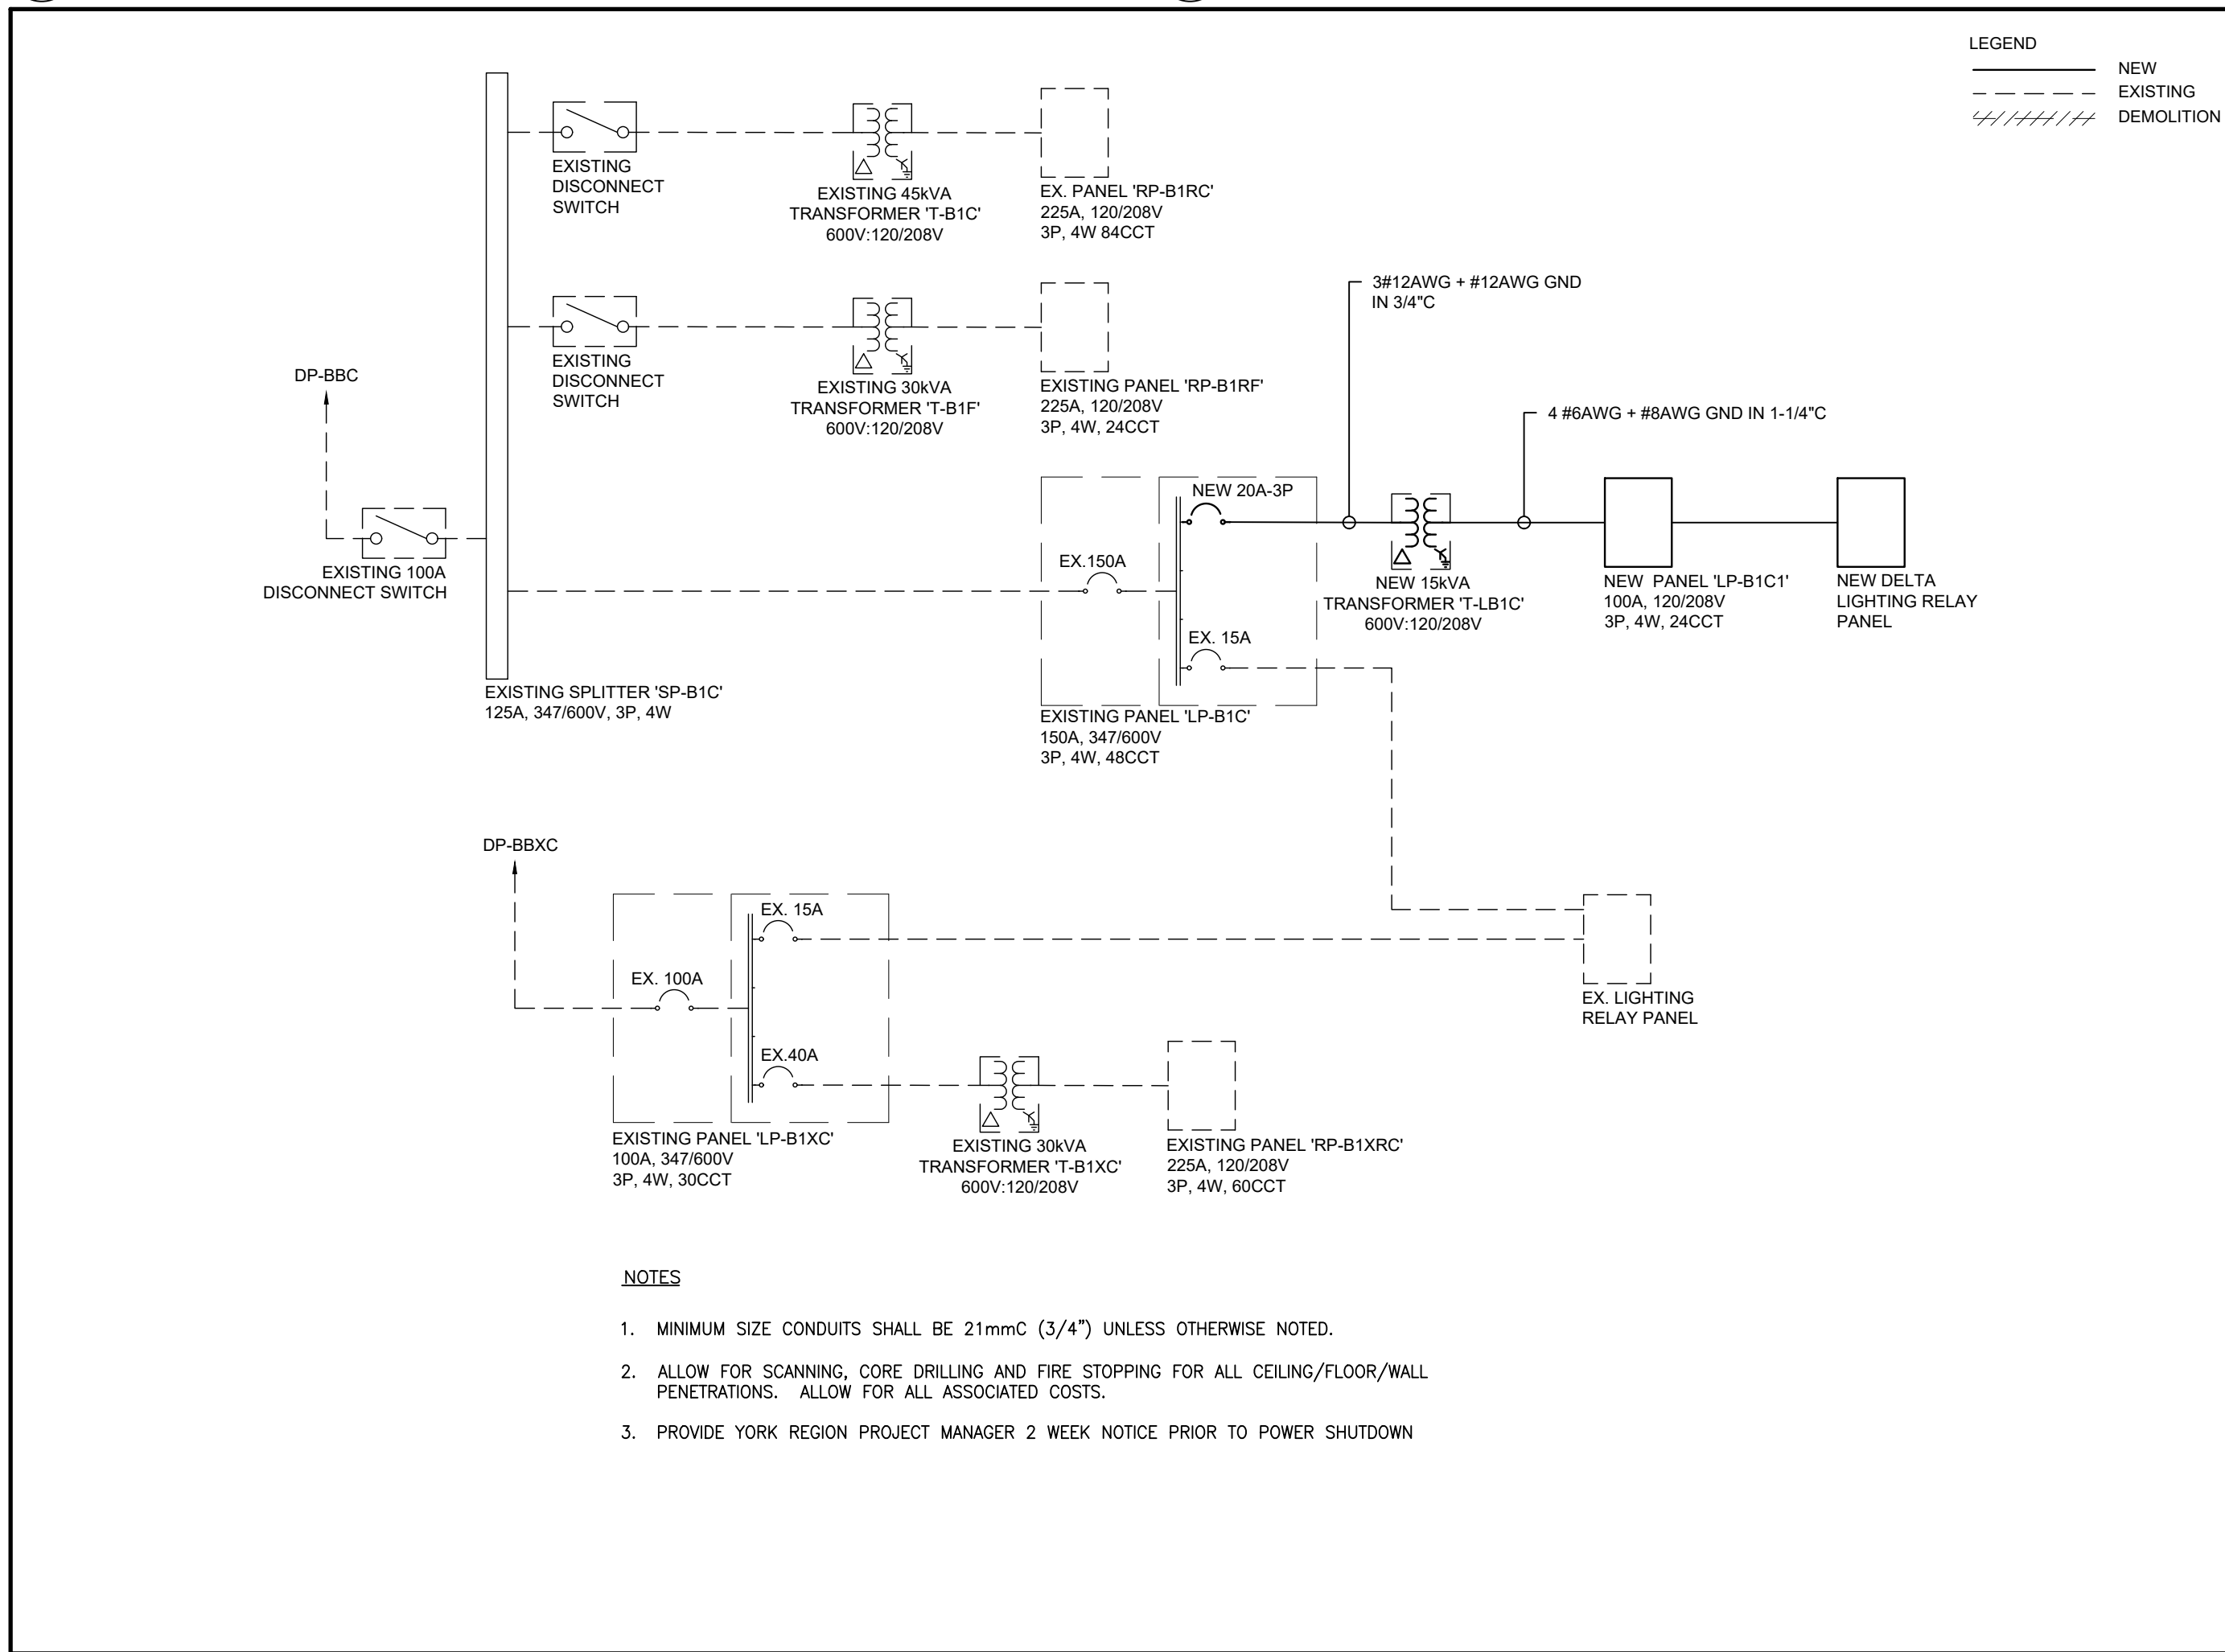



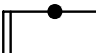
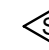





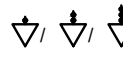




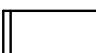

7 SINGLE LINE DIAGRAM ELECTRICAL ROOM 121

SYMBOL	DESCRIPTION	SYMBOL	DESCRIPTION
	ISOLATION TRANSFORMER - DELTA-WYE UNLESS OTHERWISE NOTED.		GROUND FAULT ALARM RELAY
	ISOLATION TRANSFORMER WITH ELECTROSTATIC SHIELD - DELTA-WYE UNLESS OTHERWISE NOTED.		IP BASED POWER QUALITY DIGITAL METER PROVIDE 21mm(3/4") CONDUIT TO NEAREST TELECOM ROOM.
	MOLDED CASE CIRCUIT BREAKER, SIZE AS SHOWN		EMERGENCY GENERATOR
	LOW VOLTAGE, DRAW-OUT CIRCUIT BREAKER, TRIP PLUG AND FRAME SIZE AS SHOWN		GROUND CONNECTION POINT
	DRAW-OUT VACUUM CIRCUIT BREAKER, PROTECTIVE RELAY FUNCTIONS AND FRAME SIZE AS SHOWN		ELECTRONIC TRIP SETTING CONTROL (GROUND FAULT)
	FUSIBLE LOAD BREAK ISOLATION SWITCH, VOLTAGE, FUSE AND FRAME SIZE AS SHOWN.		GROUND LOOP
	FUSE		HIGH RESISTANCE GROUND FAULT SYSTEM
	INSULATED CASE CIRCUIT BREAKER		LIGHTNING SURGE ARRESTOR
	INTEGRAL BREAKER AND STARTER UNIT, BREAKER AND FRAME SIZE AS SHOWN		LOAD BANK
	INTEGRAL SWITCH AND FUSE UNIT, FUSE AND FRAME SIZE AS SHOWN		ELECTRONIC TRIP SETTING CONTROL (LONG, SHORT)
	LOAD BREAK ISOLATION SWITCH, VOLTAGE AND FRAME SIZE AS SHOWN.		ELECTRONIC TRIP SETTING CONTROL (LONG, SHORT, INSTANTANEOUS)
	AUTOMATIC TRANSFER SWITCH WITH BY-PASS		ELECTRONIC TRIP SETTING CONTROL (LONG, SHORT, INSTANTANEOUS, GROUND FAULT)
	AUTOMATIC TRANSFER SWITCH WITHOUT BY-PASS		METERING SOCKET
	FIRE PUMP AUTOMATIC TRANSFER SWITCH AND STARTER UNIT (BY OTHERS)		METERING CABINET
	MANUAL TRANSFER SWITCH OR DOUBLE THROW SWITCH		DIGITAL ELECTRONIC METER
	AMMETER		SURGE PROTECTION DEVICE
	AUTO-TRANSFORMER		
	BATTERY		
	CONTACTOR		
	CURRENT TRANSFORMER		
	CURRENT TRANSFORMER (Z.S. - DENOTES ZERO SEQUENCE)		

NOTE: NOT ALL SYMBOLS APPLY, REFER TO FLOOR PLANS AND DRAWINGS

 SINGLE LINE DIAGRAM 1 OF 2

SYMBOL	DESCRIPTION	SYMBOL	DESCRIPTION
	AV EQUIPMENT RACK BY AUDIOVISUAL CONTRACTOR. REFER TO DRAWING FOR POWER REQUIREMENTS. RACK 'ID' DESIGNATION AV= FREE STANDING EQUIPMENT RACK CR= GREENE RACK. 12x12x4" AV PULL BOX BY ELECTRICAL CONTRACTOR. RC= RACK ON CASTERS. 12x12x4" AV PULL BOX BY ELECTRICAL CONTRACTOR.		PROJECTOR BY AUDIOVISUAL CONTRACTOR. 6x6x6" AV PULL BOX ABOVE FINISHED CEILING BY ELECTRICAL CONTRACTOR. REFER TO DRAWING FOR POWER REQUIREMENTS.
	WALL MOUNTED FLAT PANEL DISPLAY BY AUDIOVISUAL CONTRACTOR. 2 GANG AV MUDRING BY ELECTRICAL CONTRACTOR. REFER TO DRAWING FOR POWER REQUIREMENTS. 'DS' INDICATES DIGITAL SIGNAGE DISPLAY. REQUIRES POWER AND DATA ONLY.		PROJECTOR SCREEN BY AUDIOVISUAL CONTRACTOR. CONDUIT FOR LOW VOLTAGE CONTROL BY ELECTRICAL CONTRACTOR. REFER TO DRAWING FOR POWER REQUIREMENTS.
	CEILING MOUNTED FLAT PANEL DISPLAY BY AUDIOVISUAL CONTRACTOR. 2 GANG AV MUDRING BY ELECTRICAL CONTRACTOR. REFER TO DRAWING FOR POWER REQUIREMENTS. 'DS' INDICATES DIGITAL SIGNAGE DISPLAY. REQUIRES POWER AND DATA ONLY.		SURFACE MOUNTED SPEAKER BY AUDIOVISUAL CONTRACTOR. 1 GANG AV BACK BOX BY ELECTRICAL CONTRACTOR.
	WALL MOUNTED AV INTERFACE BY AUDIOVISUAL CONTRACTOR. 2 GANG AV MUDRING BY ELECTRICAL CONTRACTOR.		WALL MOUNTED ANTENNA BY AUDIOVISUAL CONTRACTOR. 1 GANG AV BACK BOX BY ELECTRICAL CONTRACTOR.
	BUTTON CONTROL PANEL BY AUDIOVISUAL CONTRACTOR. ELECTRICAL CONTRACTOR TO REFER TO AV COORDINATION MATRIX ON AV DRAWING SET FOR BACKBOX SIZE.		CEILING MOUNTED ANTENNA BY AUDIOVISUAL CONTRACTOR. 1 GANG AV BACK BOX ABOVE FINISHED CEILING BY ELECTRICAL CONTRACTOR.
	FLOOR BOX CONNECTION WITH AV DEDICATED COMPONENT FOR TABLETOP CONNECTIVITY. AV PLATE BY AUDIOVISUAL CONTRACTOR. FLOOR BOX BY ELECTRICAL CONTRACTOR.	AV-### 	AV MUDRING AV INPUT PLATE BY AV CONTRACTOR. AV MUDRING BY ELECTRICAL CONTRACTOR. ++1 GANG, ++2 GANG, +++3 GANG
	WALL MOUNTED AV CAMERA BY AUDIOVISUAL CONTRACTOR. 1 GANG, 3" DEEP AV BACK BOX BY ELECTRICAL CONTRACTOR.	AV-### 	AV BACKBOX AV INPUT PLATE BY AV CONTRACTOR. 3" DEEP AV BACKBOX BY ELECTRICAL CONTRACTOR. ++1 GANG, ++2 GANG, +++3 GANG
	CEILING MOUNTED AV CAMERA BY AUDIOVISUAL CONTRACTOR. 1 GANG AV BACK BOX BY ELECTRICAL CONTRACTOR.		
	AV CABLE PULL BOX BY ELECTRICAL CONTRACTOR. SIZE DESIGNATION: 6x6x6" CABLE PULL BOX 12x12" 12x12x6" CABLE PULL BOX		

NOTE: NOT ALL SYMBOLS APPLY. REFER TO FLOOR PLANS AND DRAWINGS REFER TO AV COORDINATION MATRIX OR AV CONSULTANT DRAWINGS FOR BACK BOX SIZE, MOUNTING HEIGHT AND ALL INFRASTRUCTURE REQUIREMENTS.

2 AUDIOVISUAL



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NOTE

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6.	ISSUED FOR TENDER	2026.02.24
5.	ISSUED FOR TENDER	2026.01.30
4.	ISSUED FOR PERMIT	2026.01.16
3.	ISSUED FOR 100% REVIEW	2025.11.14
2.	ISSUED FOR 90% REVIEW	2025.10.03
1.	ISSUED FOR 60% REVIEW	2025.06.27
NO.	ISSUED/REVISION	DATE



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PROJECT

YORK REGION
MUNICIPALITY CENTRE

PROJECT ADDRESS

17250 YONGE STREET, NEWMARKET, ONTARIO L3Y 4W5

TITLE

ELECTRICAL LEGEND AND DETAIL

PROJECT NO.	DRAWN	CHECKED
14008-025-E	JB	WYC/NC

DRAWING NO. _____ SCALE _____

TE-0.2

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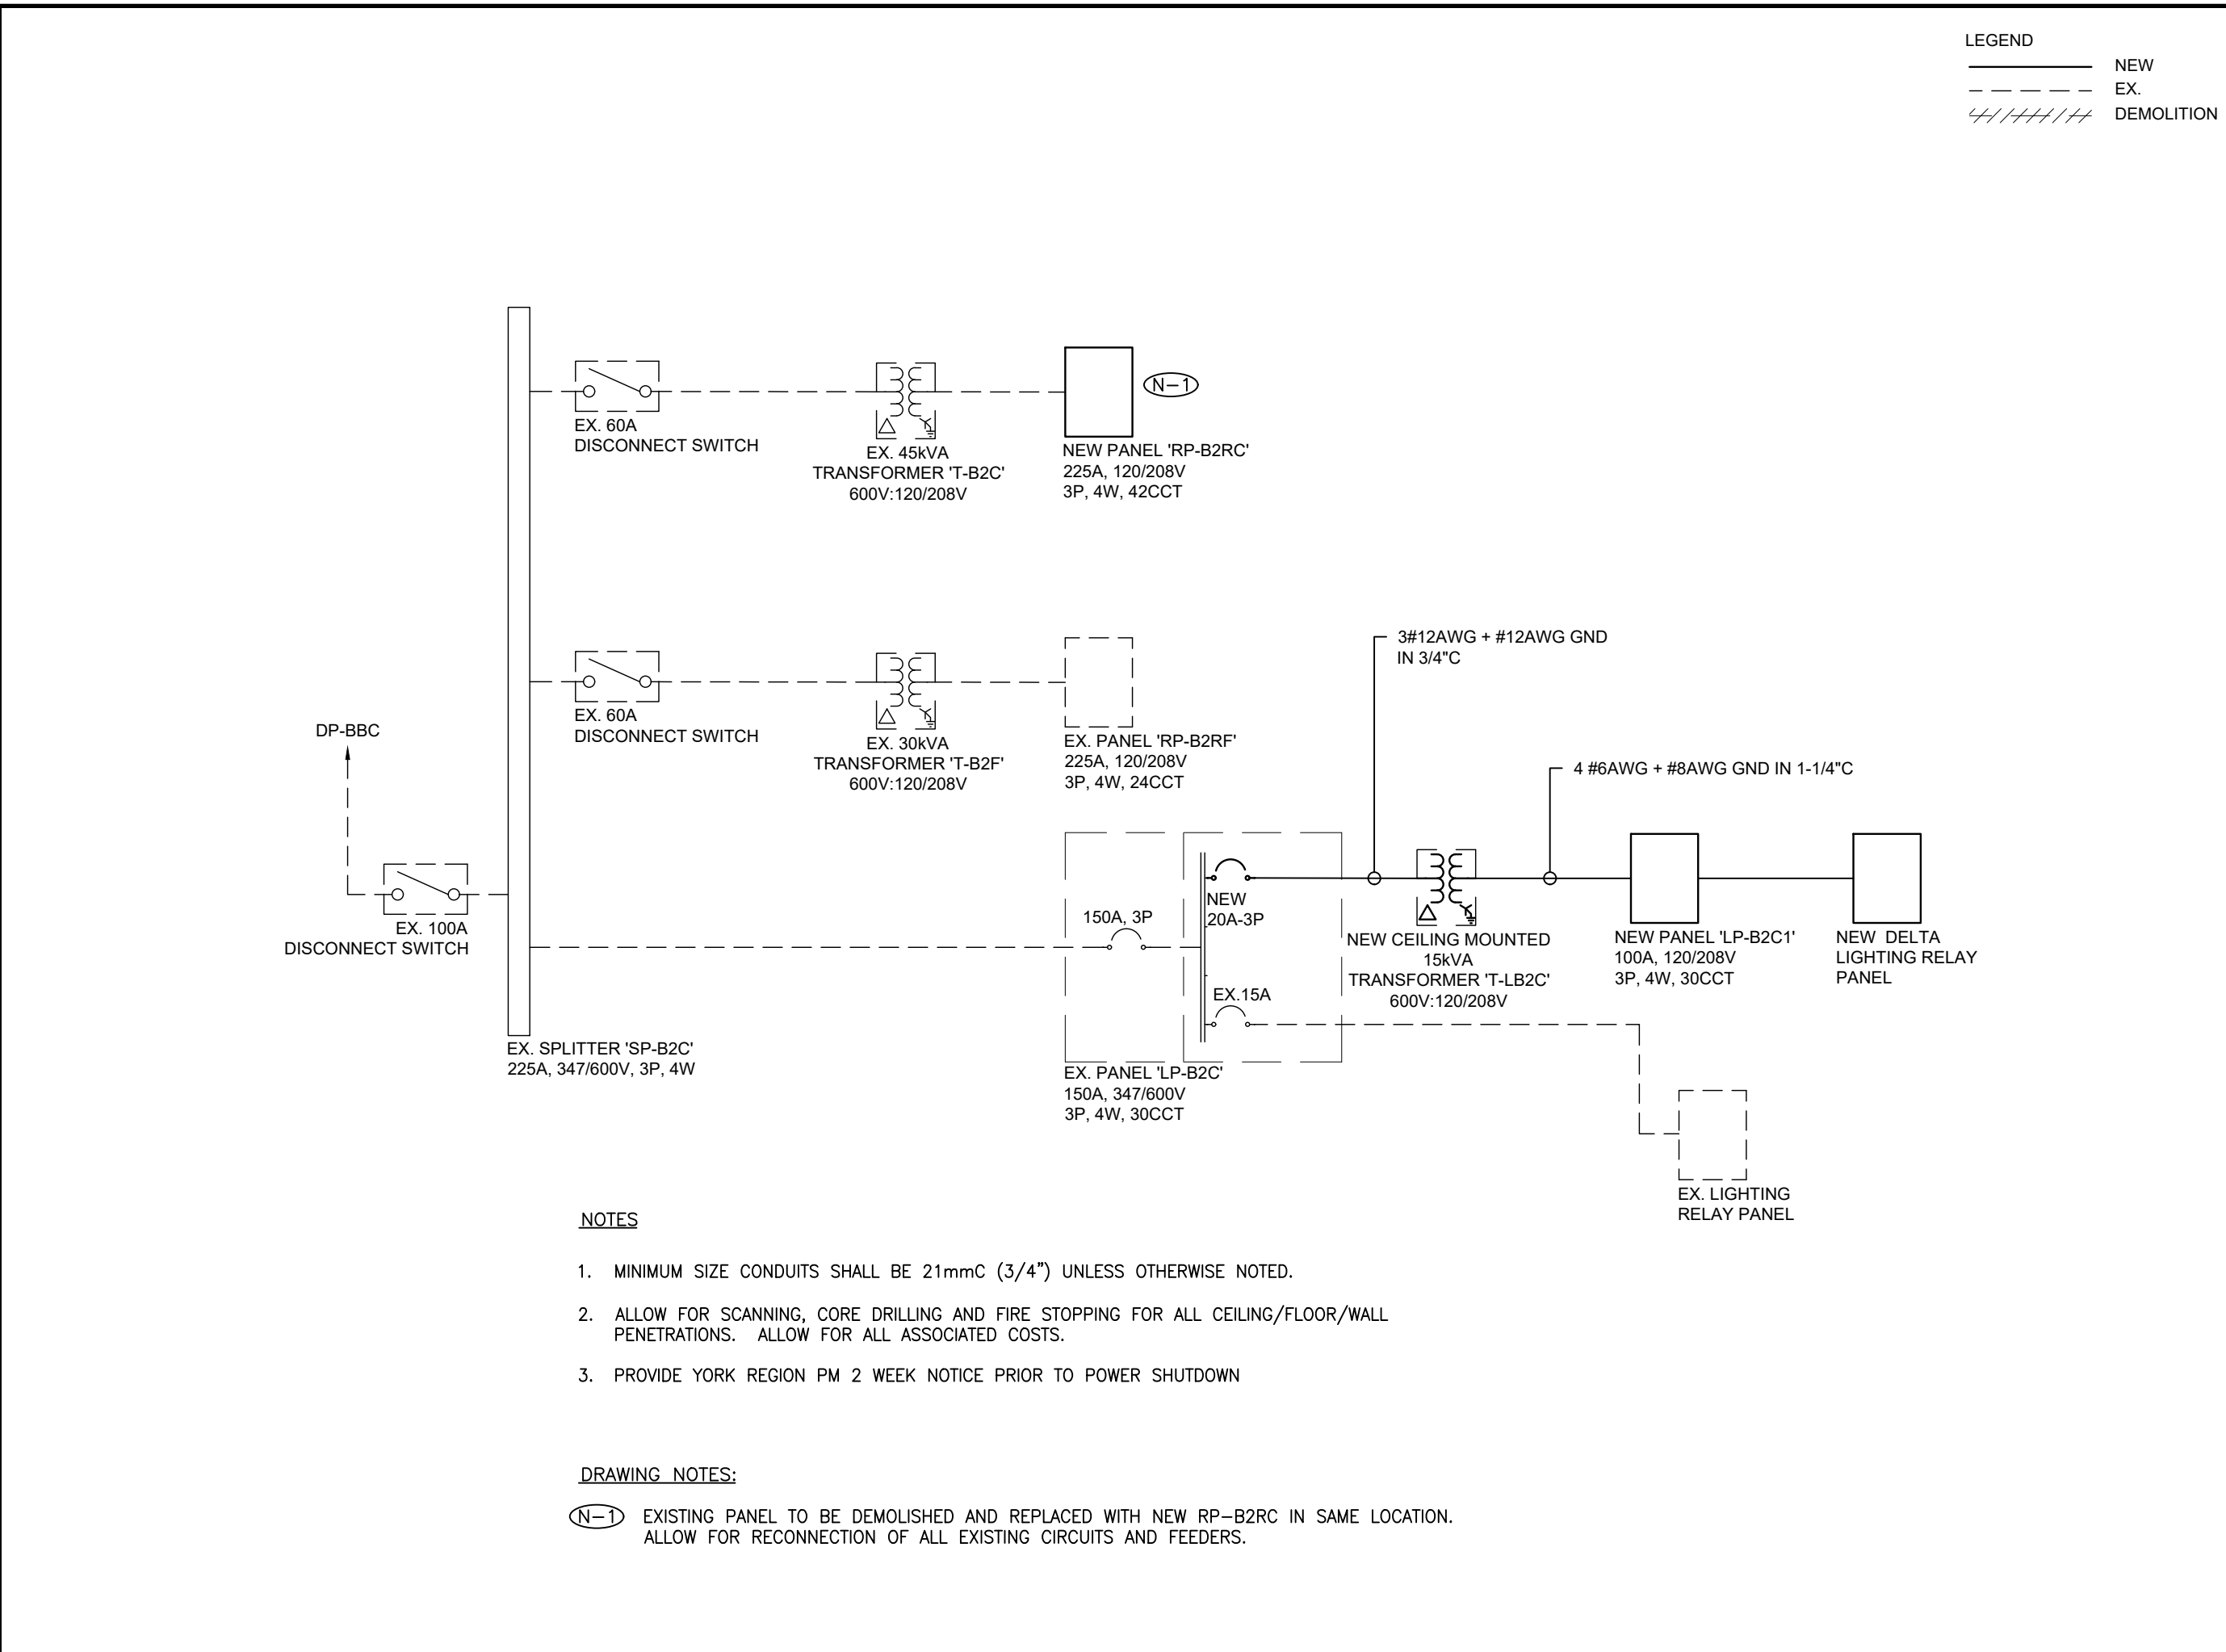
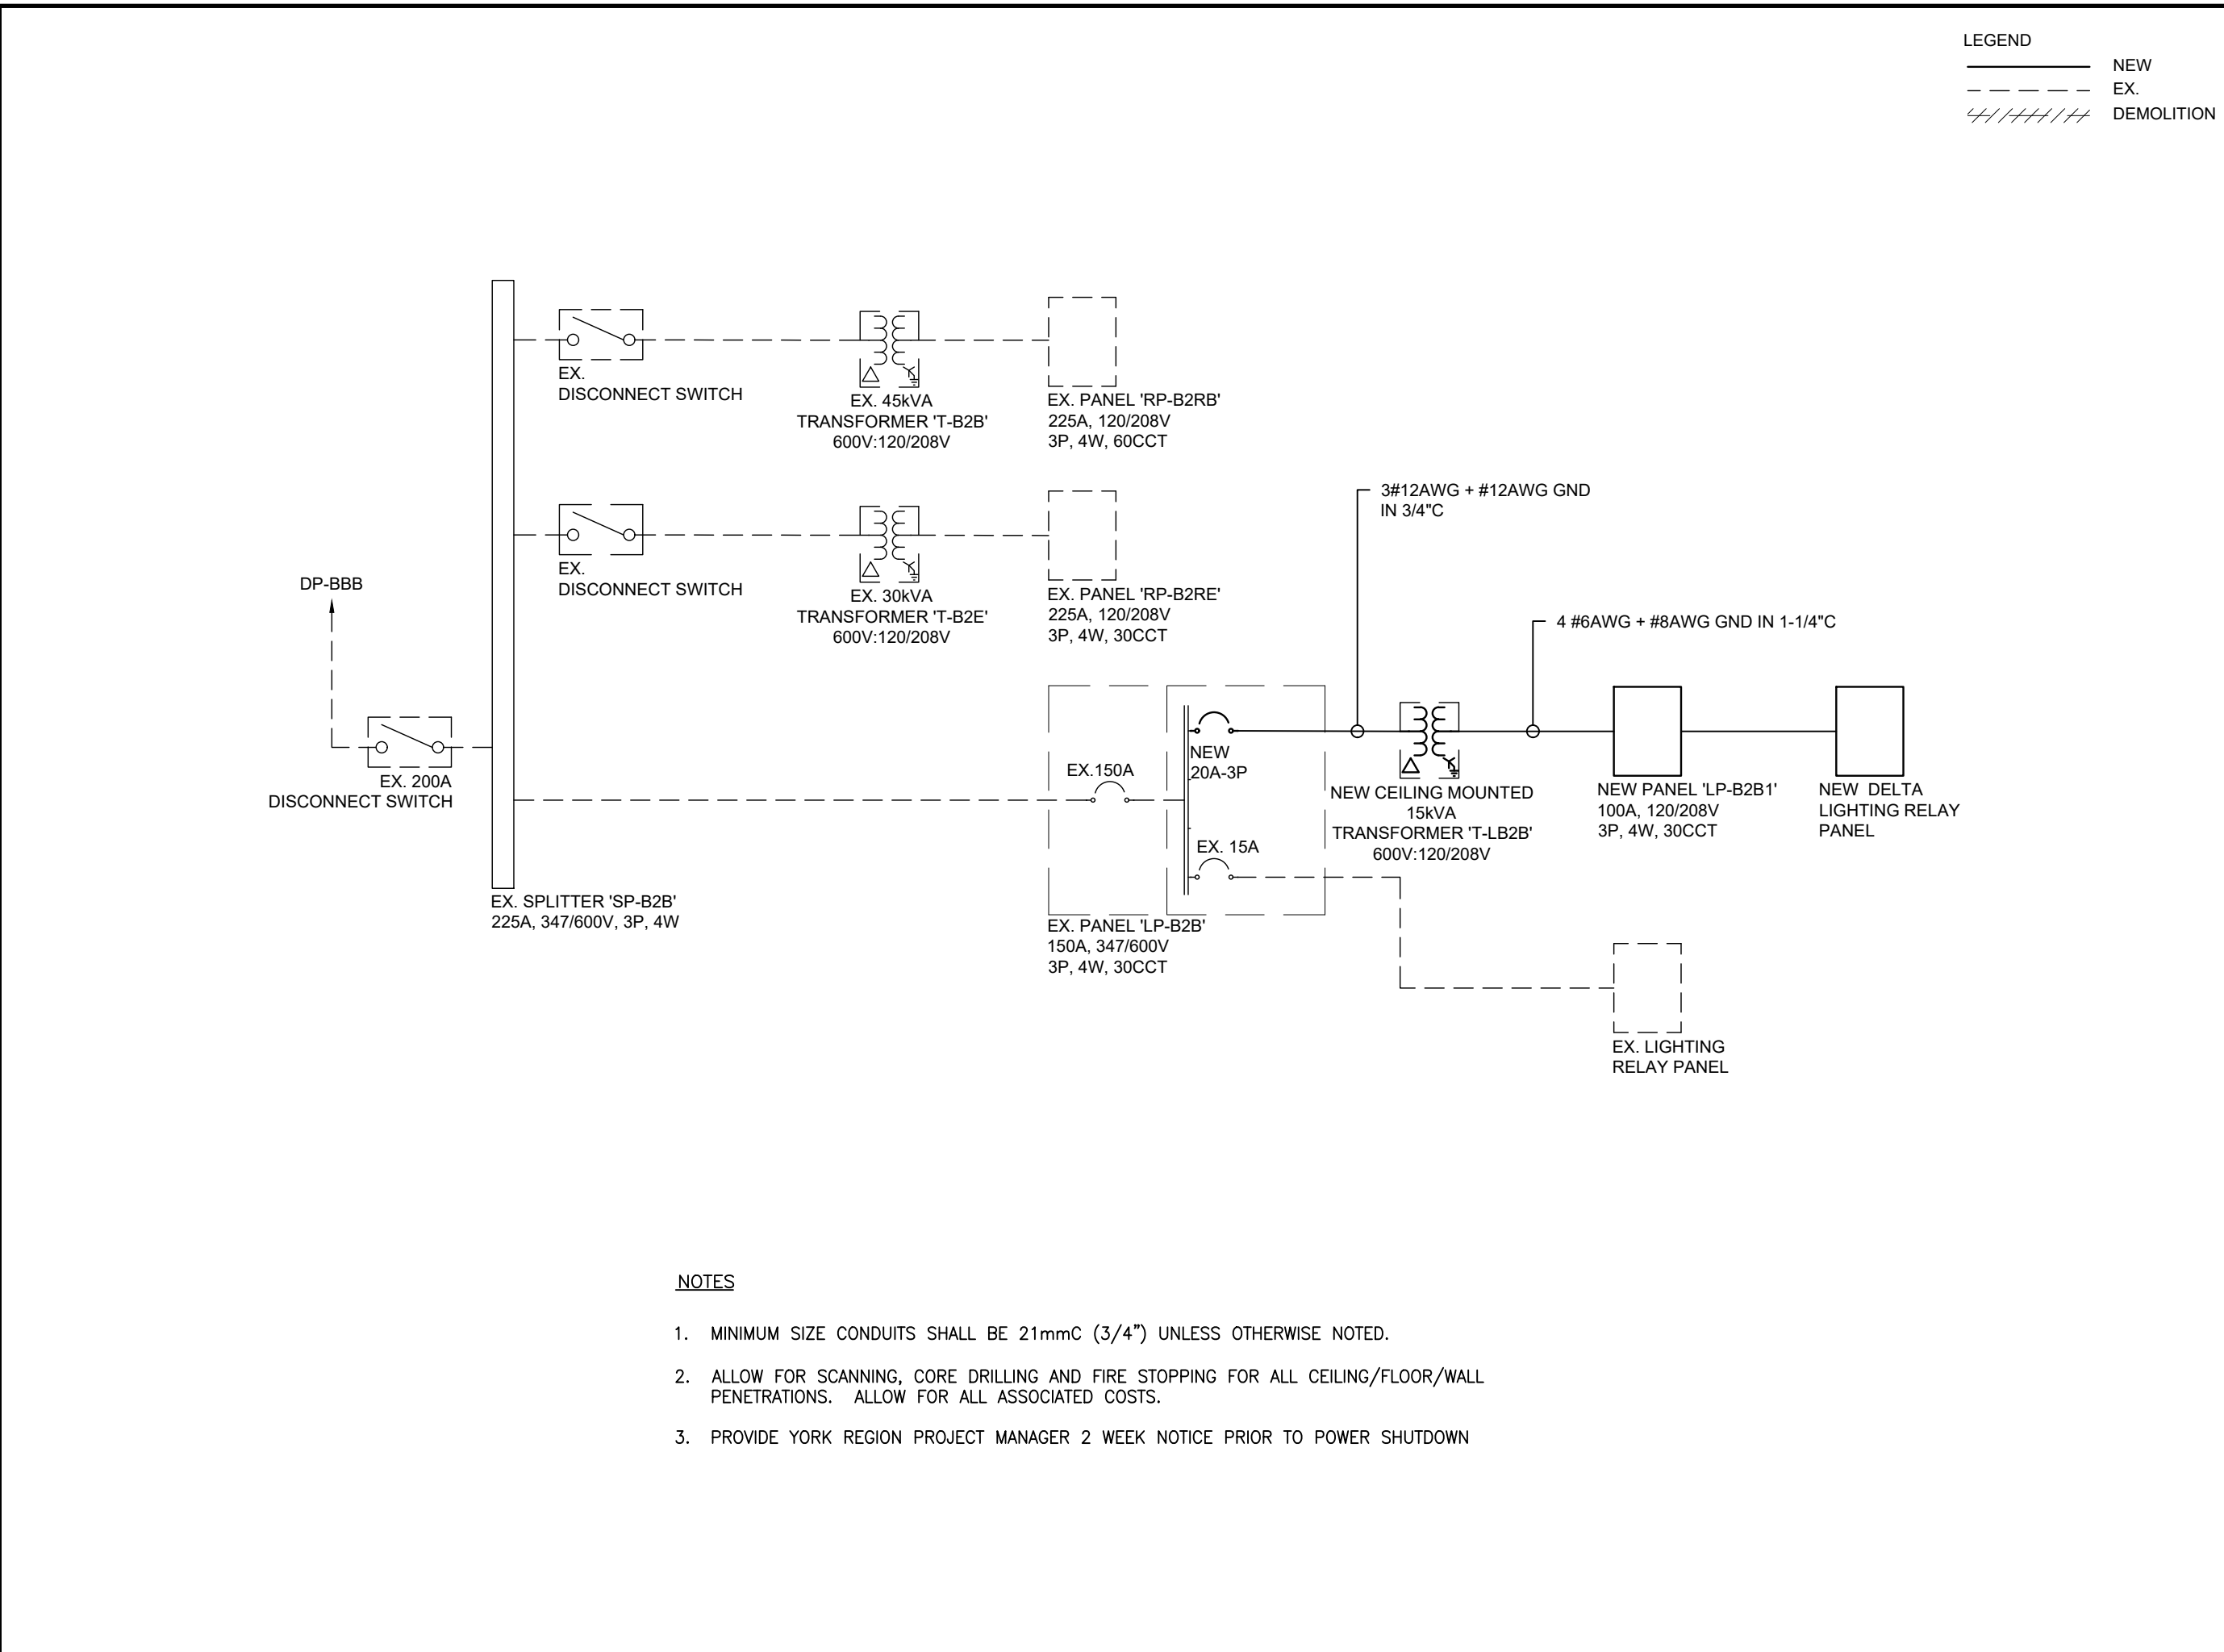
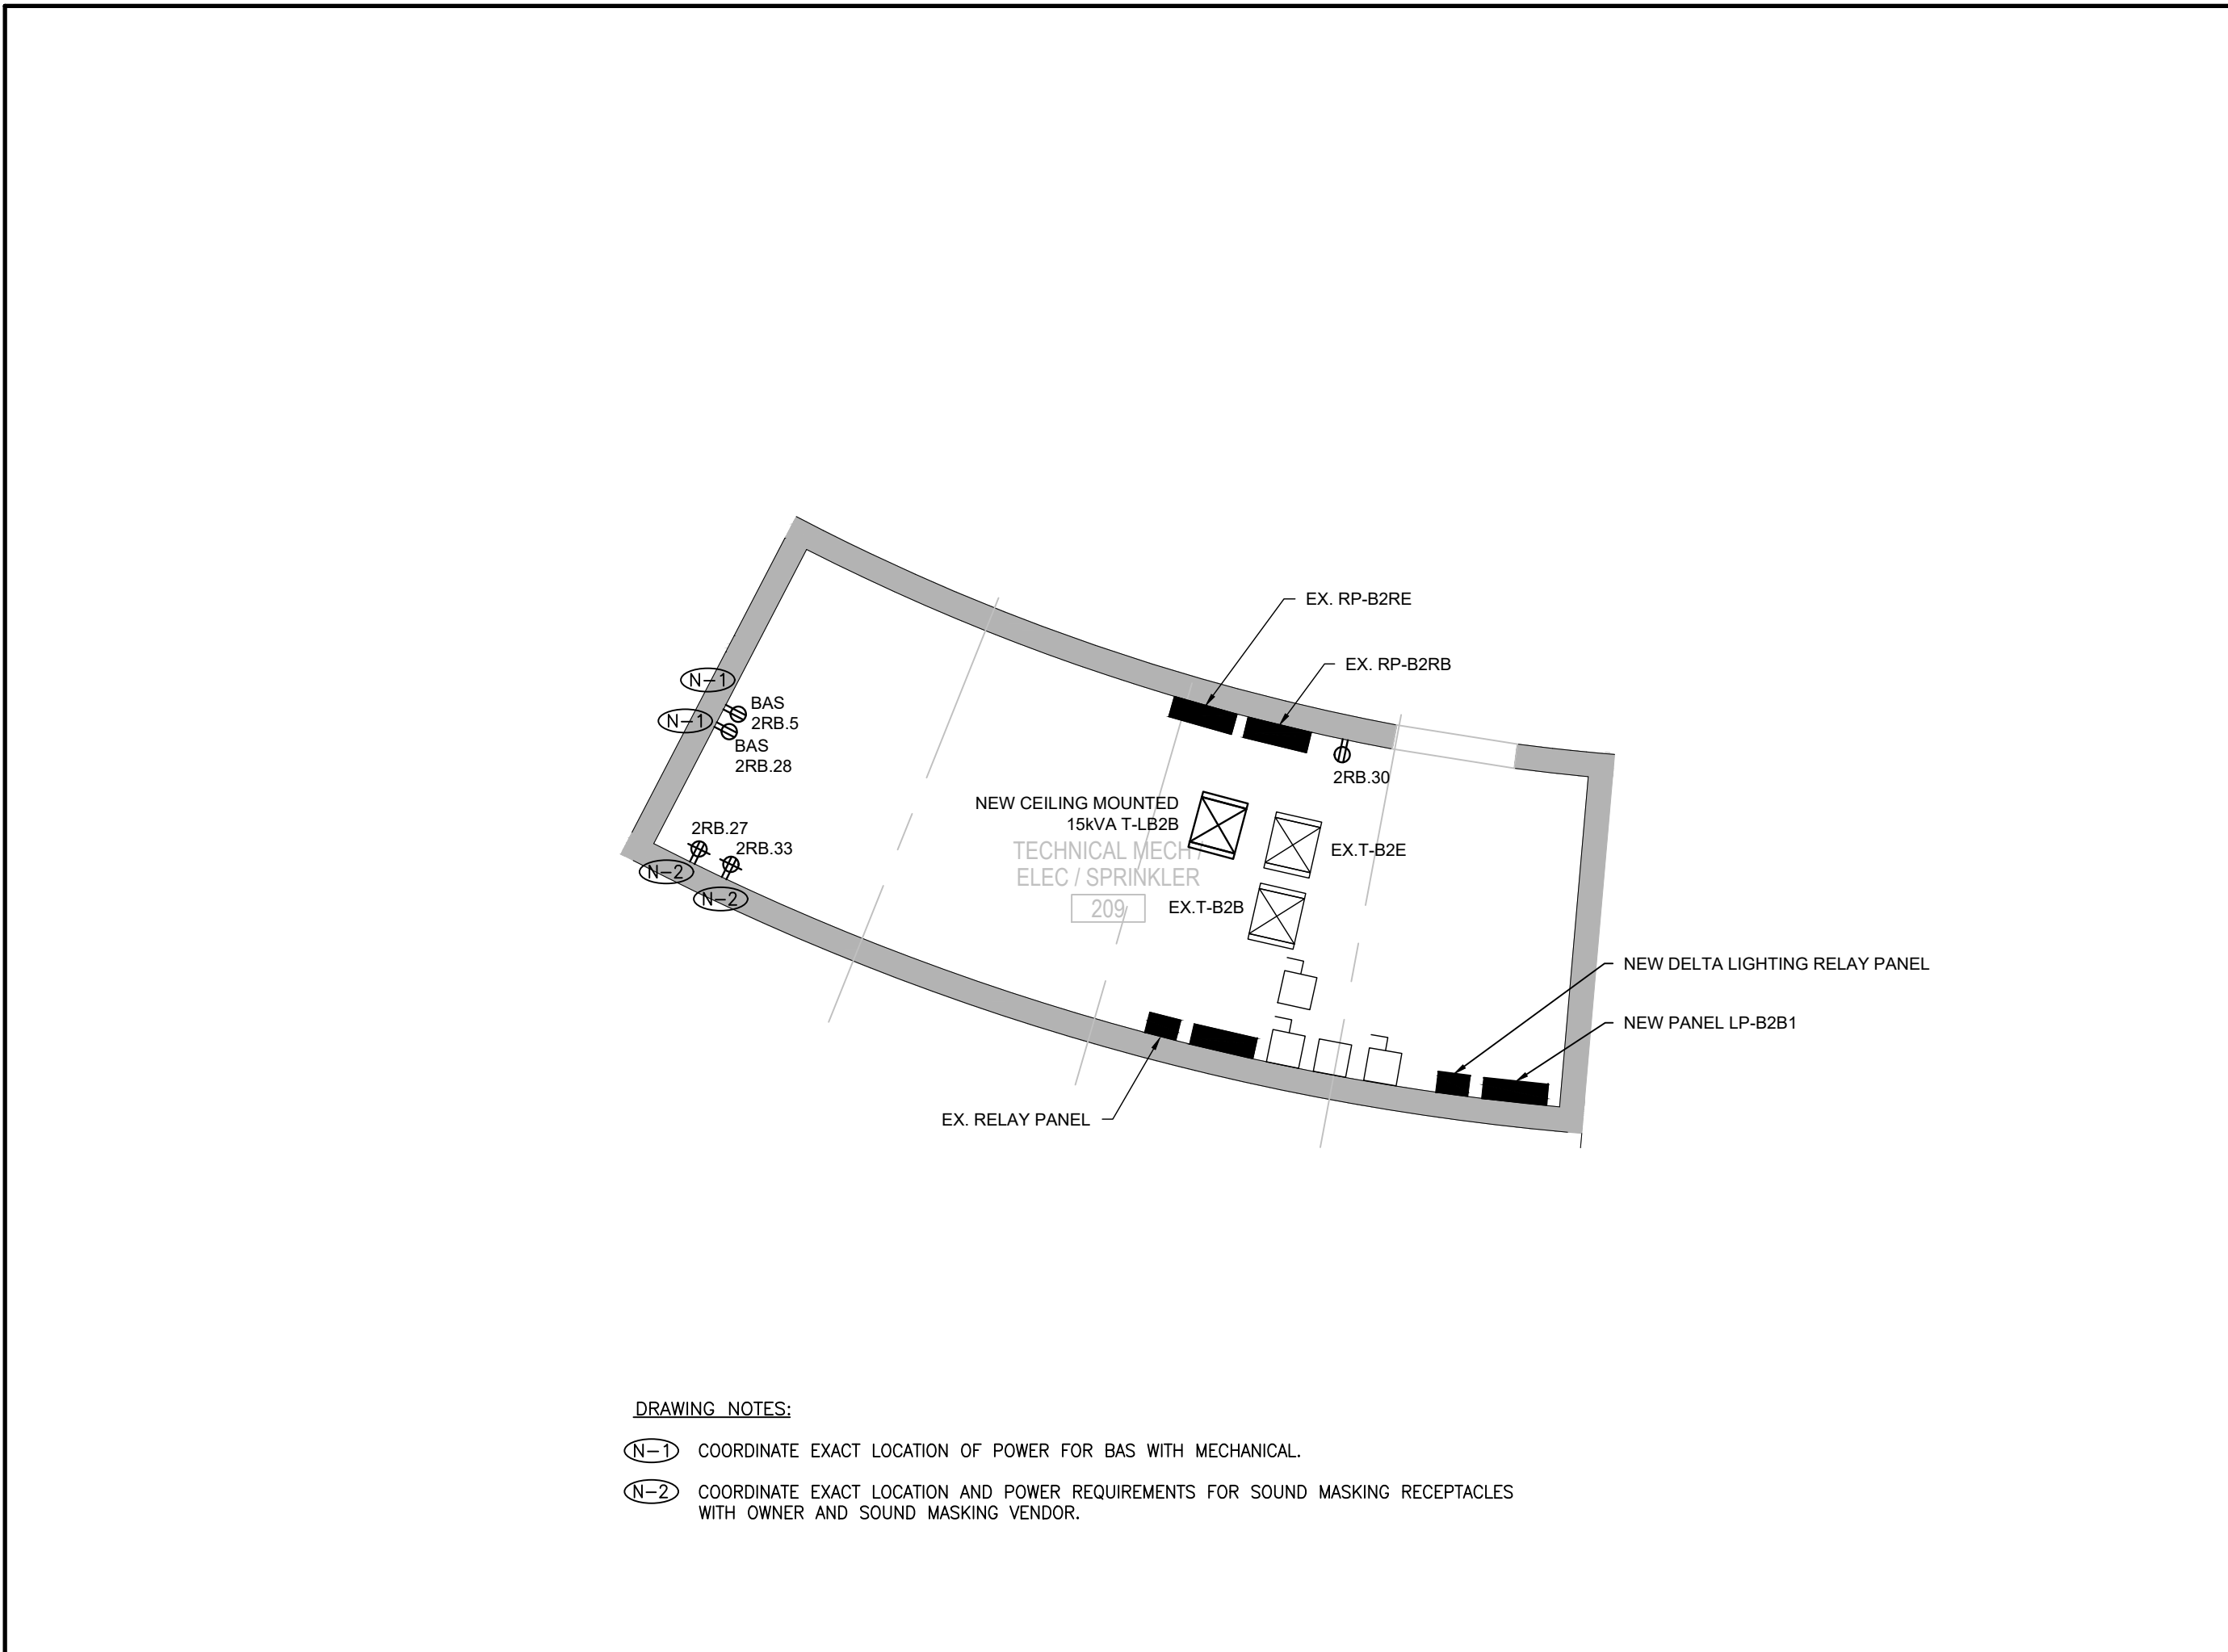
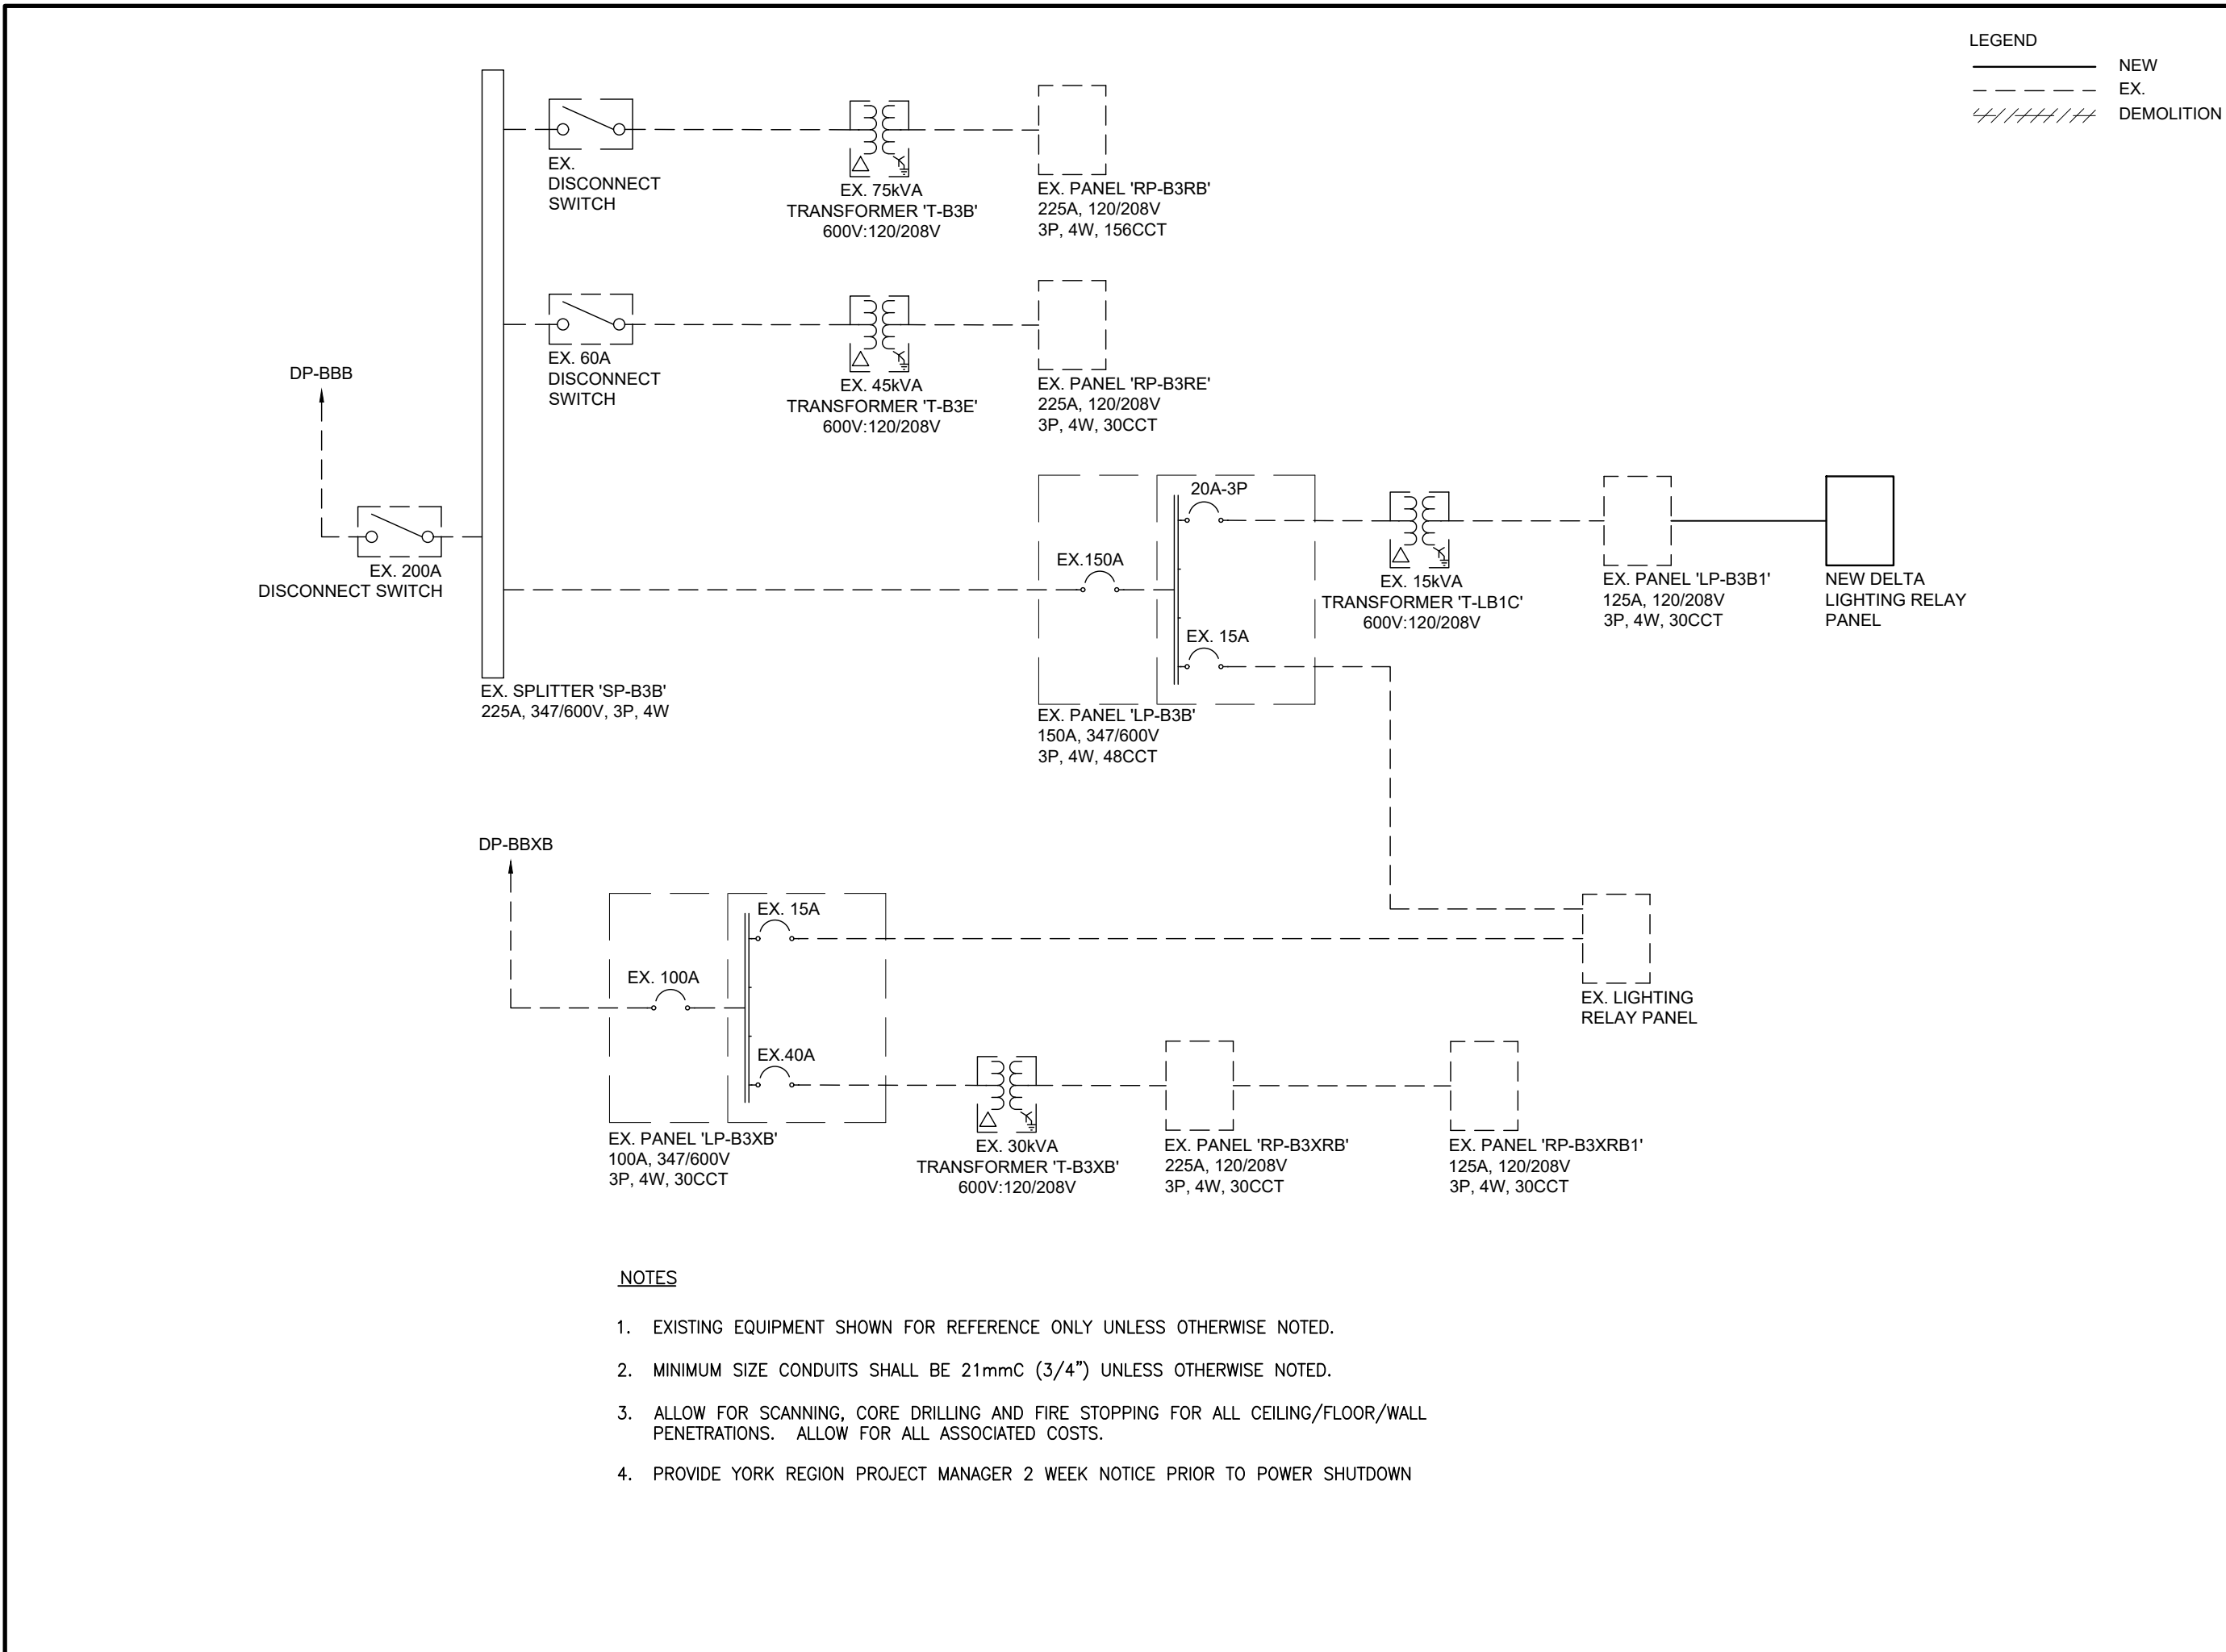
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TITLE

ELECTRICAL DETAIL

PROJECT NO. 14008-025-E
DRAWN JB
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DRAWING NO. TE-0.3
SCALE N.T.S



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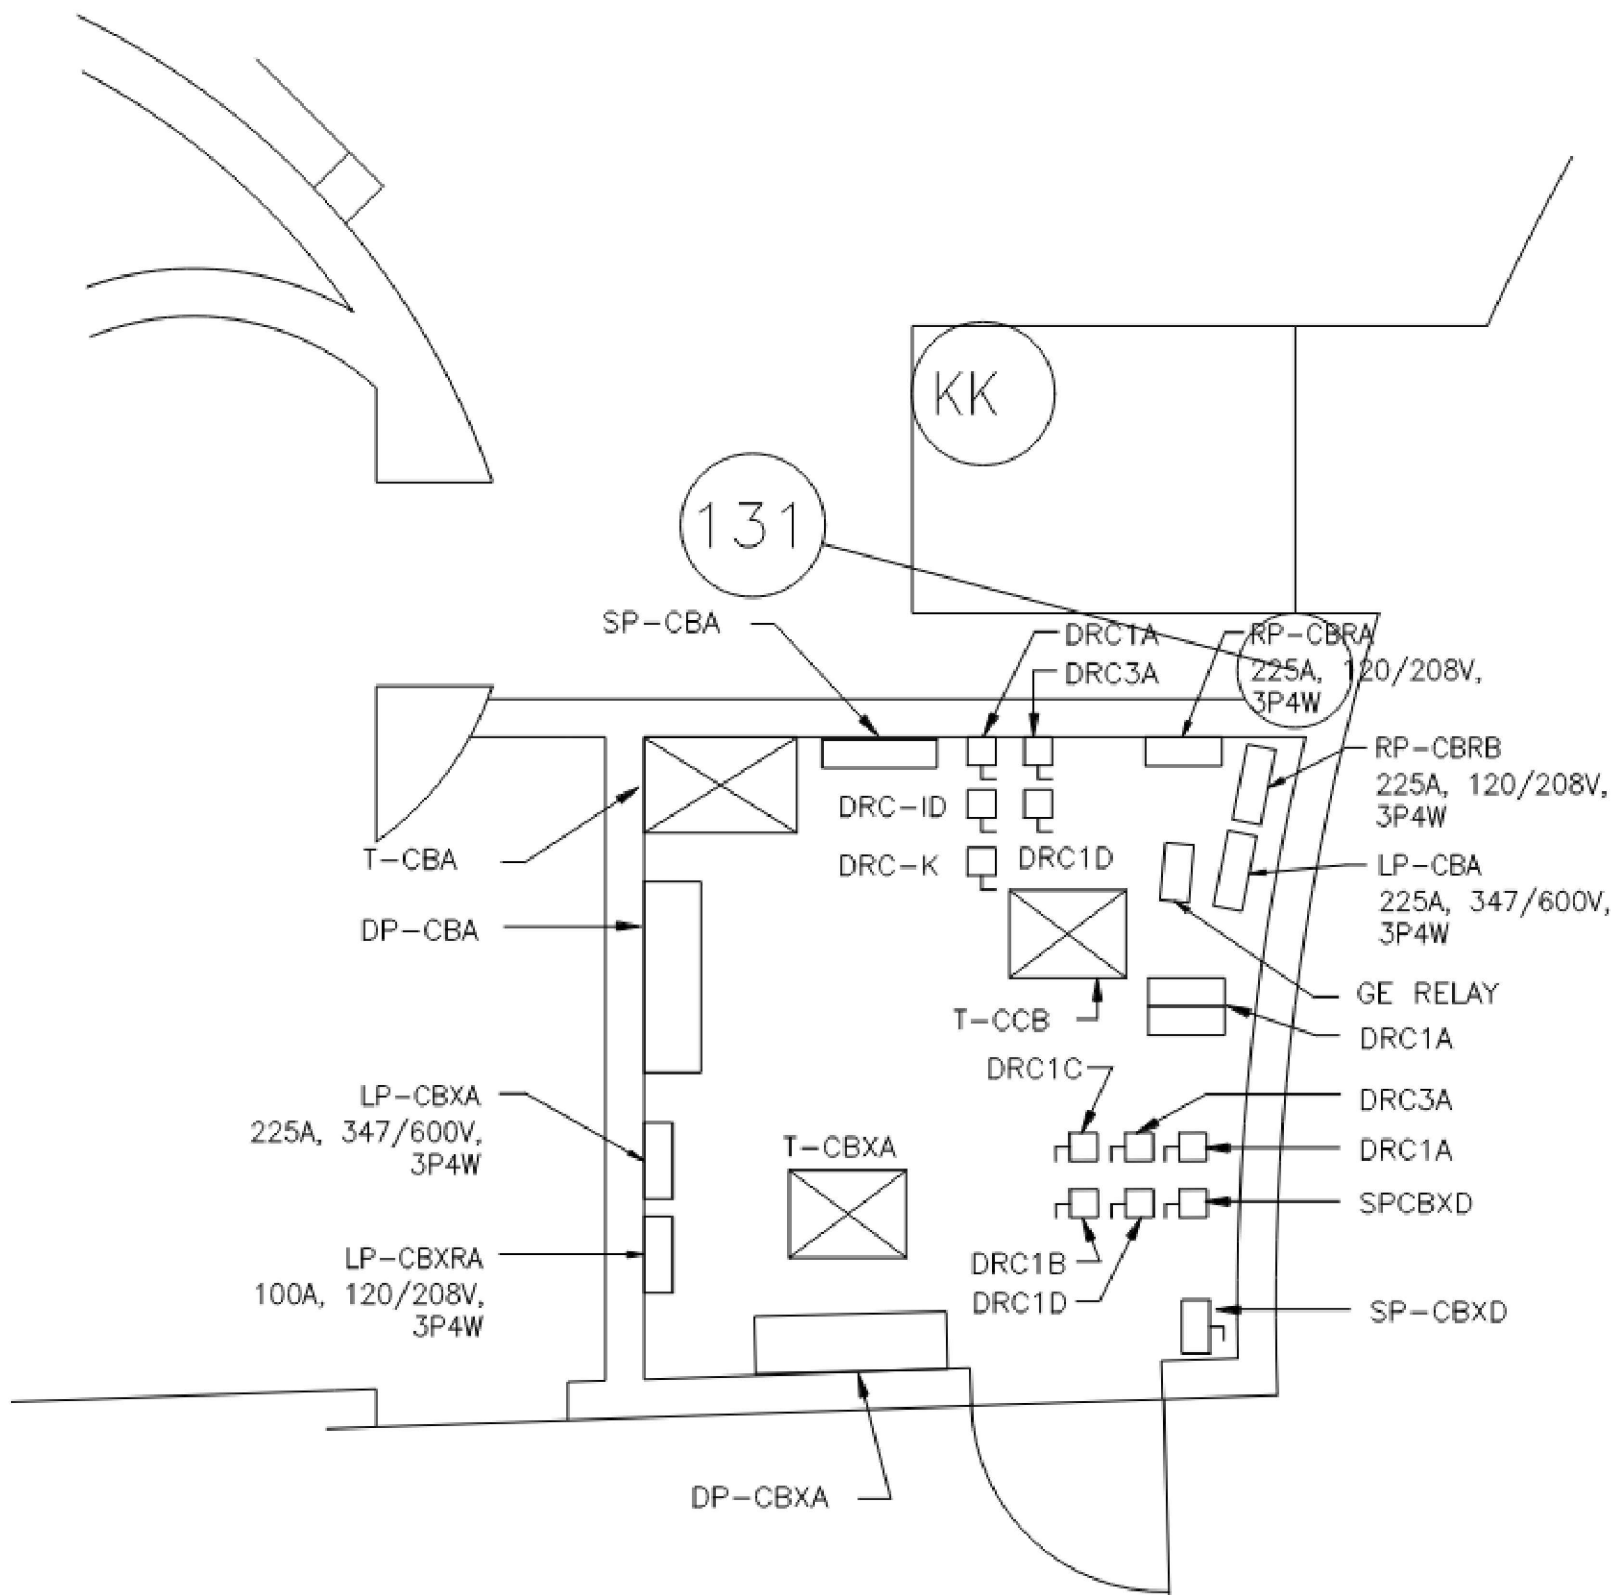
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ELECTRICAL DETAIL


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DRAWING NO.	SCALE
TE-0.4	N.T.S




NOTES
1. ALL EQUIPMENT SHOWN IS EXISTING AND SHOWN FOR REFERENCE ONLY.

3 "P1" LEVEL ELECTRICAL ROOM
TE-0.4

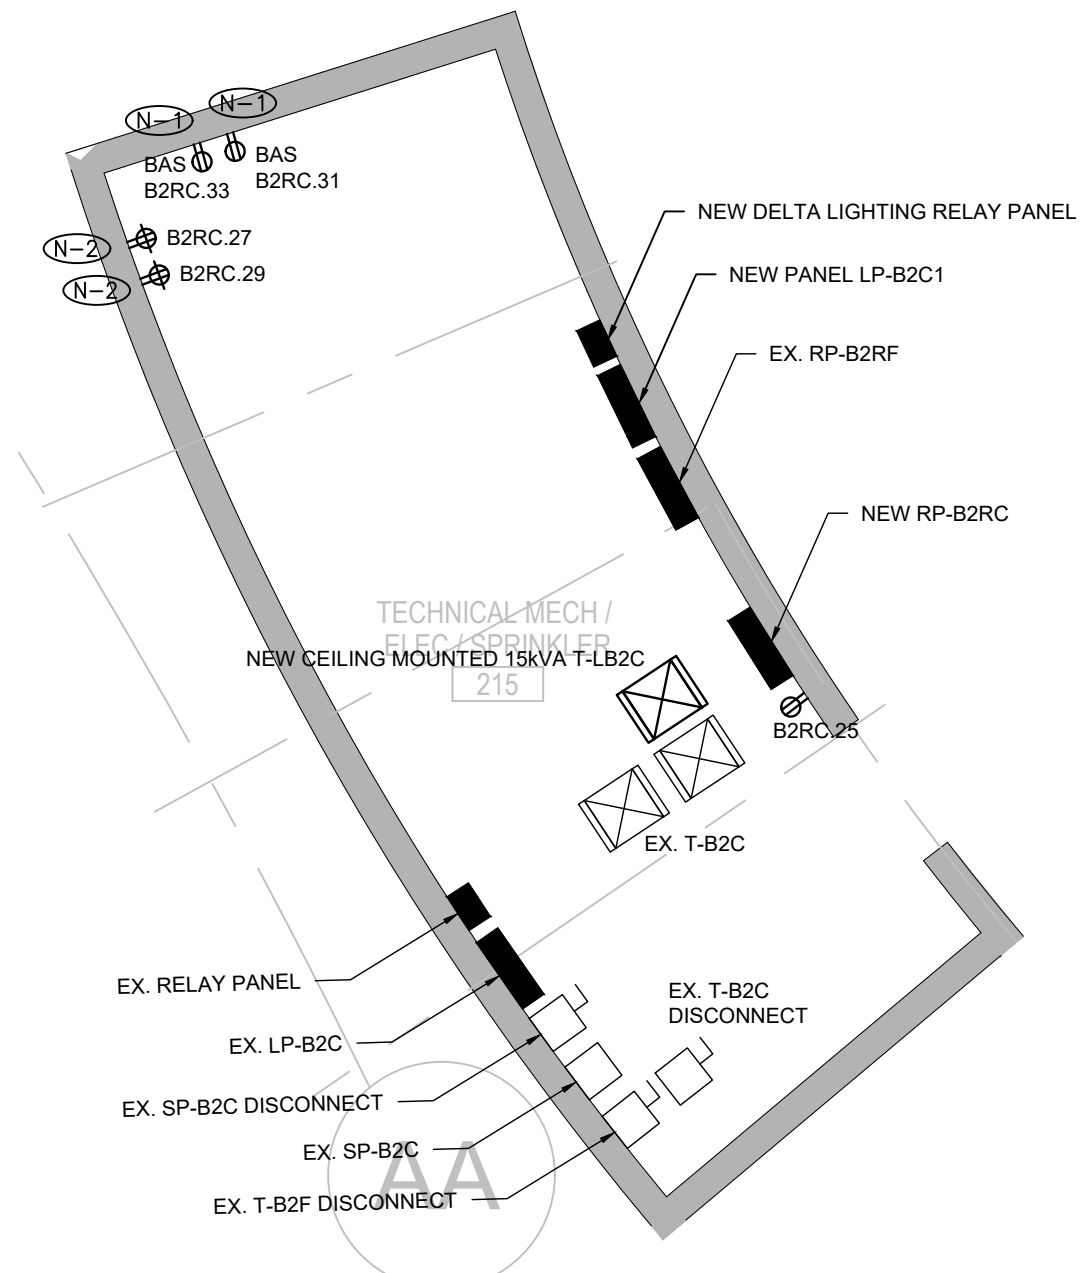

DRAWING NOTES:
N-1 COORDINATE EXACT LOCATION OF POWER FOR BAS WITH MECHANICAL.
N-2 COORDINATE EXACT LOCATION AND POWER REQUIREMENTS FOR SOUND MASKING RECEPTACLES WITH OWNER AND SOUND MASKING VENDOR.

1 ELECTRICAL ROOM 215 DETAIL
TE-0.4

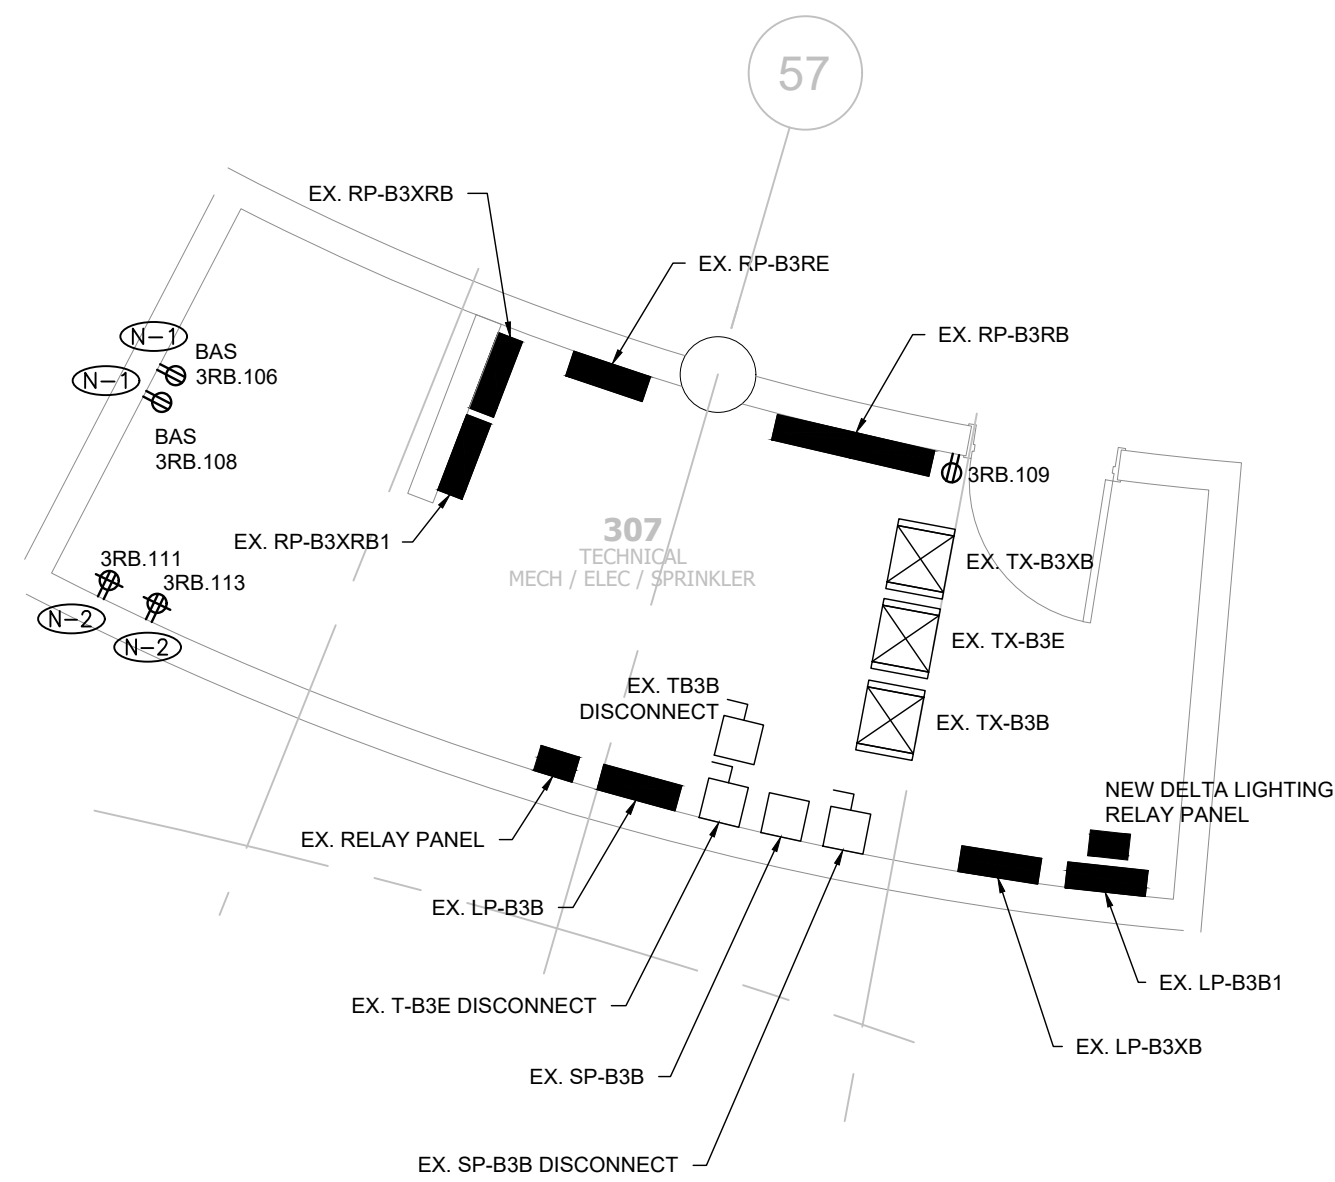

DRAWING NOTES:
N-1 COORDINATE EXACT LOCATION OF POWER FOR BAS WITH MECHANICAL.
N-2 COORDINATE EXACT LOCATION AND POWER REQUIREMENTS FOR SOUND MASKING RECEPTACLES WITH OWNER AND SOUND MASKING VENDOR.

2 ELECTRICAL ROOM 307 DETAIL
TE-0.4

NOTE

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PROJECT

YORK REGION
MUNICIPALITY CENTRE

PROJECT ADDRESS


17250 YONGE STREET, NEWMARKET, ONTARIO L3Y 4W5

TITLE

ELECTRICAL DETAIL

PROJECT NO. 14008-025-E
DRAWN JB
CHECKED WYC/NC

DRAWING NO. TE-0.5
SCALE N.T.S


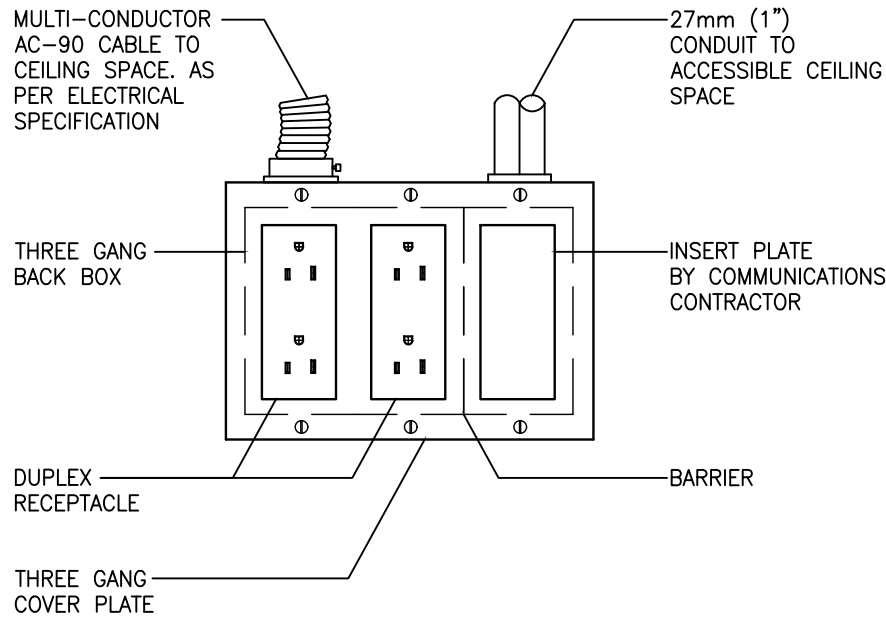


DRAWING SYMBOLS




NOTES:

- (N-1) PROVIDE CONNECTOR, C/W NYLON BUSHINGS FOR CONDUIT TERMINATIONS WITHIN ACCESSIBLE CEILING SPACE.
- (N-2) PROVIDE PULL STRINGS IN ALL EMPTY CONDUIT.
- (N-3) COVER PLATES BY DIVISION ELECTRICAL CONTRACTOR.

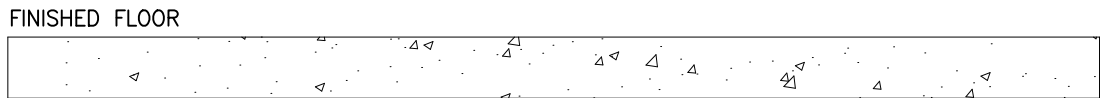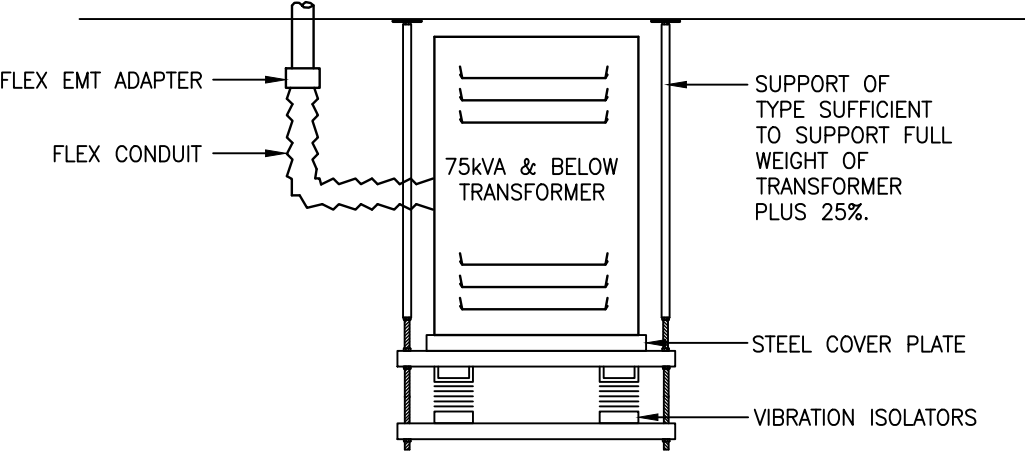

6 TRANSFORMER INSTALLATION DETAIL

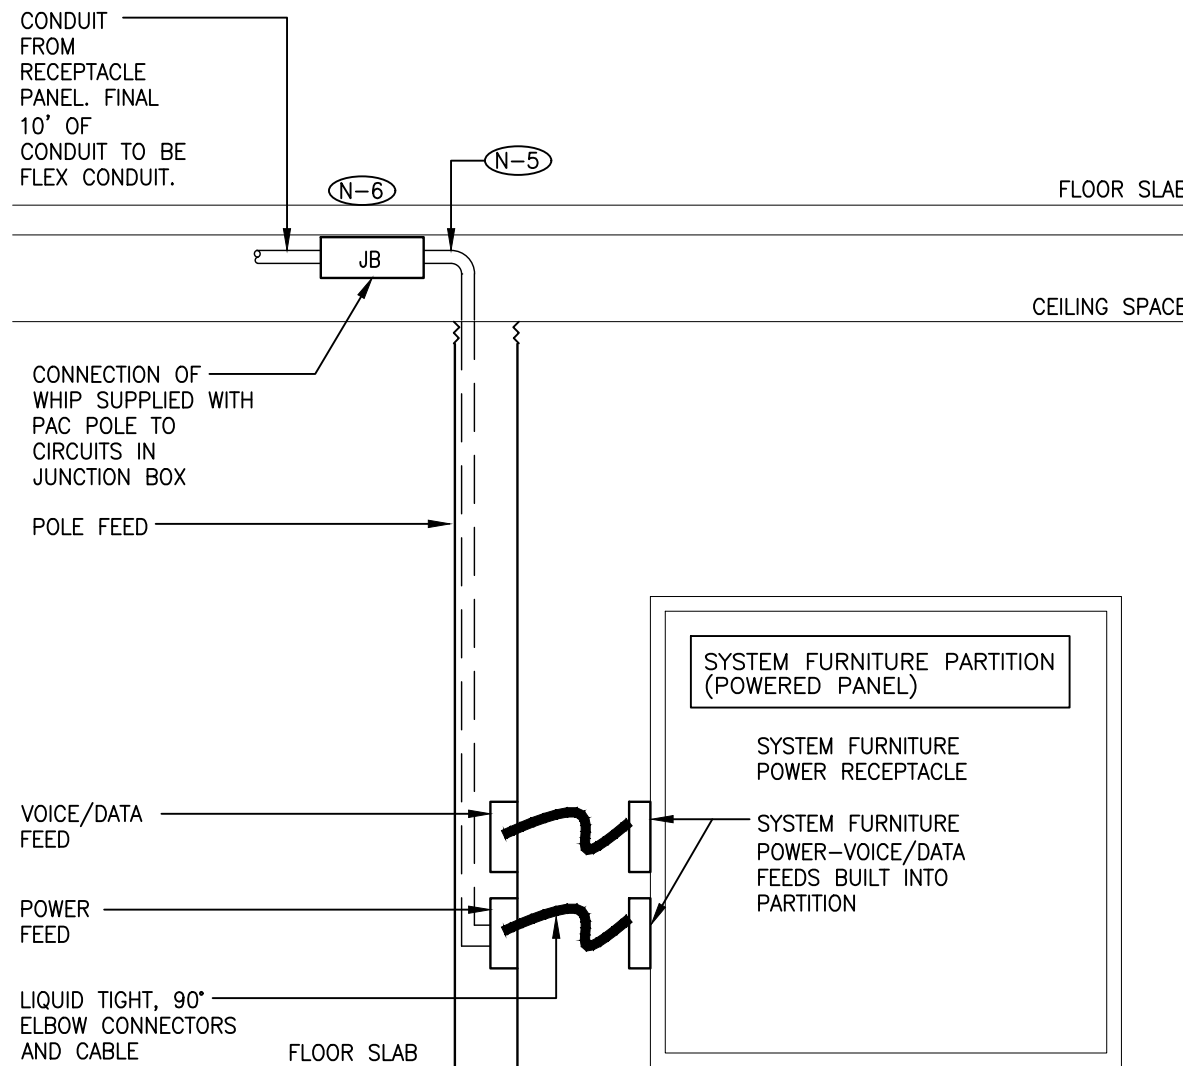


DRAWING SYMBOLS



NOTES:

- (N-1) JUNCTION BOXES TO BE MOUNTED TO UNDERSIDE OF SLAB.
- (N-2) COORDINATE INSTALLATION OF VOICE/DATA HARDWARE WITH CABLING CONTRACTOR PRIOR TO ROUGH-IN.
- (N-3) MINIMUM SIZE OF POWER CONDUITS IS 3/4".
- (N-4) COORDINATE EXACT LOCATIONS WITH YORK REGION AND ARCHITECT PRIOR TO ROUGH-IN.
- (N-5) FURNITURE MANUFACTURER SUPPLIED WIRING HARNESS. ELECTRICAL CONTRACTOR TO TERMINATE USING 90° FLEX CONNECTOR SIZED TO MATCH HARNESS.
- (N-6) CONTRACTOR TO ALLOW FOR AN ADDITIONAL 10' OF CABLING + CONDUIT FOR RELOCATION OF PAC POLE

4 PAC POLE SYSTEM FURNITURE FEED

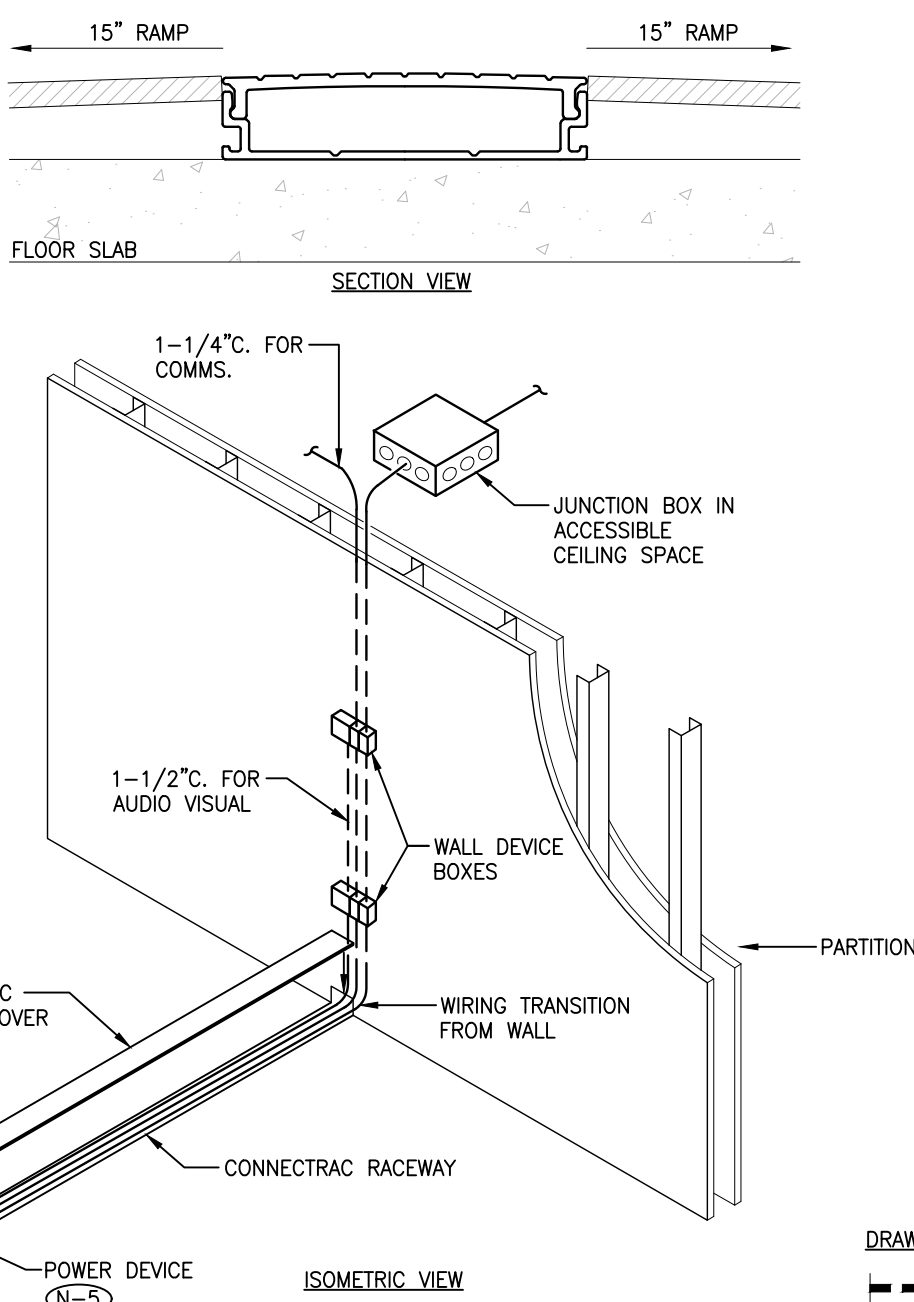

NOTES:

- (N-1) REFER TO PLANS FOR CONNECTRAC RACEWAY LOCATIONS. BASE SYSTEM SHALL BE UNDER CARPET WIREWAY SYSTEM LEGRAND CONNECTRAC FLEX SYSTEM.
- (N-2) SUPPLY AND INSTALL RACEWAYS AND POWER/COMMS. DEVICES AS INDICATED. CONSULT WITH MANUFACTURER FOR COMPLETE REQUIREMENTS AND PROVIDE ALL REQUIRED COMPONENTS AND ACCESSORIES FOR A COMPLETE AND WORKING INSTALLATION.
- (N-3) COORDINATE EXACT LOCATION AND ROUTING OF RACEWAY WITH YORK REGION AND ARCHITECT ON SITE PRIOR TO INSTALLATION. RACEWAYS TO BE FIELD CUT AS REQUIRED. PROVIDE 45° OR 90° CORNER KITS WHERE NECESSARY.
- (N-4) MINIMUM SIZE OF POWER CONDUITS IS 3/4".
- (N-5) PROVIDE POWER DEVICE C/W DUPLEX RECEPTACLES AND DEVICE BOXES/MUDRINGS FOR COMMUNICATIONS/AUDIO & VIDEO USE AS SHOWN ON THE PLAN. COORDINATE EXACT LOCATION WITH YORK REGION AND ARCHITECT PRIOR TO ROUGH-IN.

5 CONNECTRAC RACEWAY SYSTEM AND MEETING ROOM TV WALL DETAIL

OCCUPANCY SENSOR SCHEDULE		
TYPE	DESCRIPTION	MANUFACTURER/CATALOGUE NO.
CS	DUAL TECHNOLOGY LINE VOLTAGE CEILING OCCUPANCY SENSOR.	WATTSTOPPER CAT# DT-355 OR EQUIVALENT
CS ^A	DUAL TECHNOLOGY LOW VOLTAGE CEILING OCCUPANCY SENSOR C/W POWER PACK BZ-250.	WATTSTOPPER CAT# DT-300 OR EQUIVALENT
CS	DUAL TECHNOLOGY LINE VOLTAGE WALL OCCUPANCY SENSOR.	WATTSTOPPER CAT# DSW-301 OR EQUIVALENT
D	WALL MOUNTED 0-10V DIMMER SWITCH	WATTSTOPPER CAT# DCLV2 OR EQUIVALENT


1 LIGHTING CONTROL SCHEDULE

LUMINAIRE SCHEDULE				
TYPE	LAMP TYPE	VOLTAGE	DESCRIPTION	MANUFACTURER/CATALOGUE NO.
L1	LED	120V	LINEAR RECESSED 1'x4' FLAT PANEL LED FIXTURE.	LITELINE: CAT# LEDB-14-WH
L2	LED 14.3W 4000K	120V	4" DOWNLIGHT, 0-10V DIMMING	PRESCOLITE - LITEFRAME CAT#LFR-4RD-RFH-SL10L-40K-8-MD-DM -120V-
L3	LED 30W 4000K	120V	6" LED RECESSED DOWNLIGHT RETROFIT, 0-10V DIMMING, 347 STEP-DOWN TRANSFORMER C/W MOUNTING HARDWARE & ACCESSORIES REQUIRED.	PRESCOLITE CAT# LBRST-RD
//	//	//	//	//
L5	LED 374W	120V	AV LIGHT FIXTURE	MARTIN CAT# ERA600 PROFILE
EXIT SIGNS	LED	120V	EDGE-LIT LED 'GREEN RUNNING MAN' PICTOGRAM SIGN.	BEGHELLI CAT# GD-RM-L-RC-1-OLR-120/347V-UDC C/W ALL MOUNTING ACCESSORIES

NOTES:

- (N-1) ALL FIXTURES SHALL BE APPROVED FOR USE IN CANADA (E.G. CSA, ULIC).
- (N-2) FIXTURES C/W ALL REQUIRED MOUNTING ACCESSORIES.
- (N-3) CONFIRM ALL FINISHES AND MOUNTING HEIGHTS WITH ARCHITECTURAL DRAWINGS PRIOR TO ORDERING.
- (N-4) CONTRACTOR TO PROVIDE 347-120V LIGHTING TRANSFORMER AS REQUIRED


2 LUMINAIRE SCHEDULE

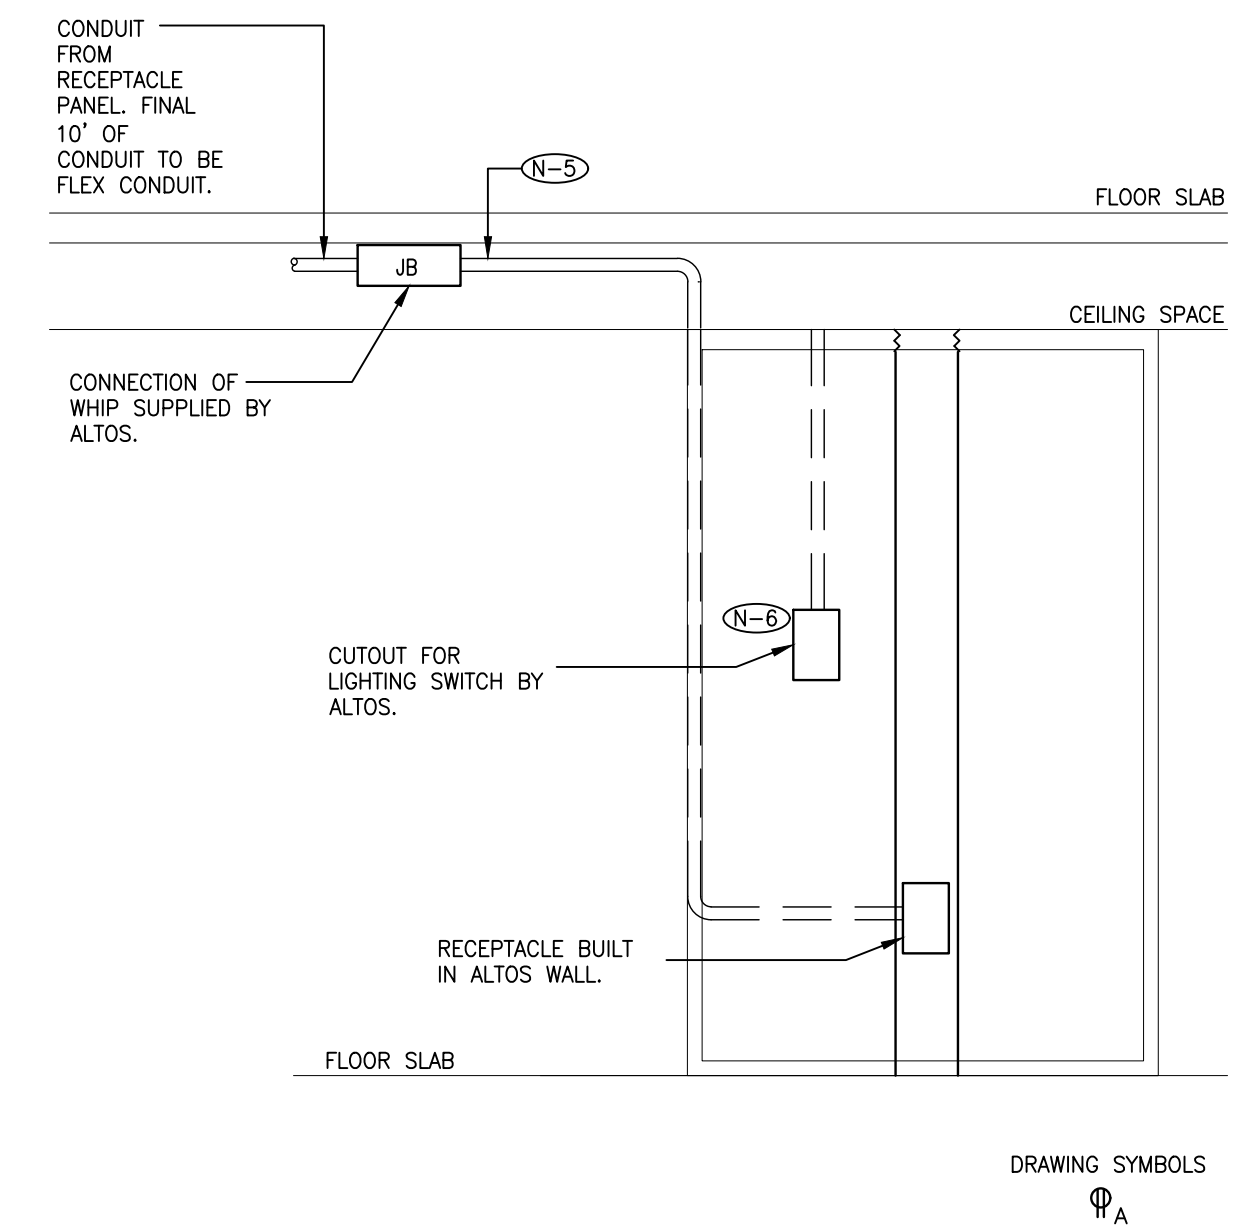

NOTES:

- (N-1) JUNCTION BOXES TO BE MOUNTED TO UNDERSIDE OF SLAB.
- (N-2) COORDINATE INSTALLATION OF VOICE/DATA HARDWARE WITH CABLING CONTRACTOR PRIOR TO ROUGH-IN.
- (N-3) MINIMUM SIZE OF POWER CONDUITS IS 3/4".
- (N-4) COORDINATE EXACT LOCATIONS WITH YORK REGION AND ARCHITECT PRIOR TO ROUGH-IN.
- (N-5) FURNITURE MANUFACTURER SUPPLIED WIRING HARNESS. ELECTRICAL CONTRACTOR TO TERMINATE USING 90° FLEX CONNECTOR SIZED TO MATCH HARNESS.
- (N-6) WIRING, CONDUIT AND DEVICES BY ELECTRICAL CONTRACTOR. THE CUTOUT FOR THE LIGHTING SWITCH BY ALTOS. COORDINATE EXACT LOCATIONS WITH ALTOS.


3 ALTOS SYSTEM FURNITURE FEED

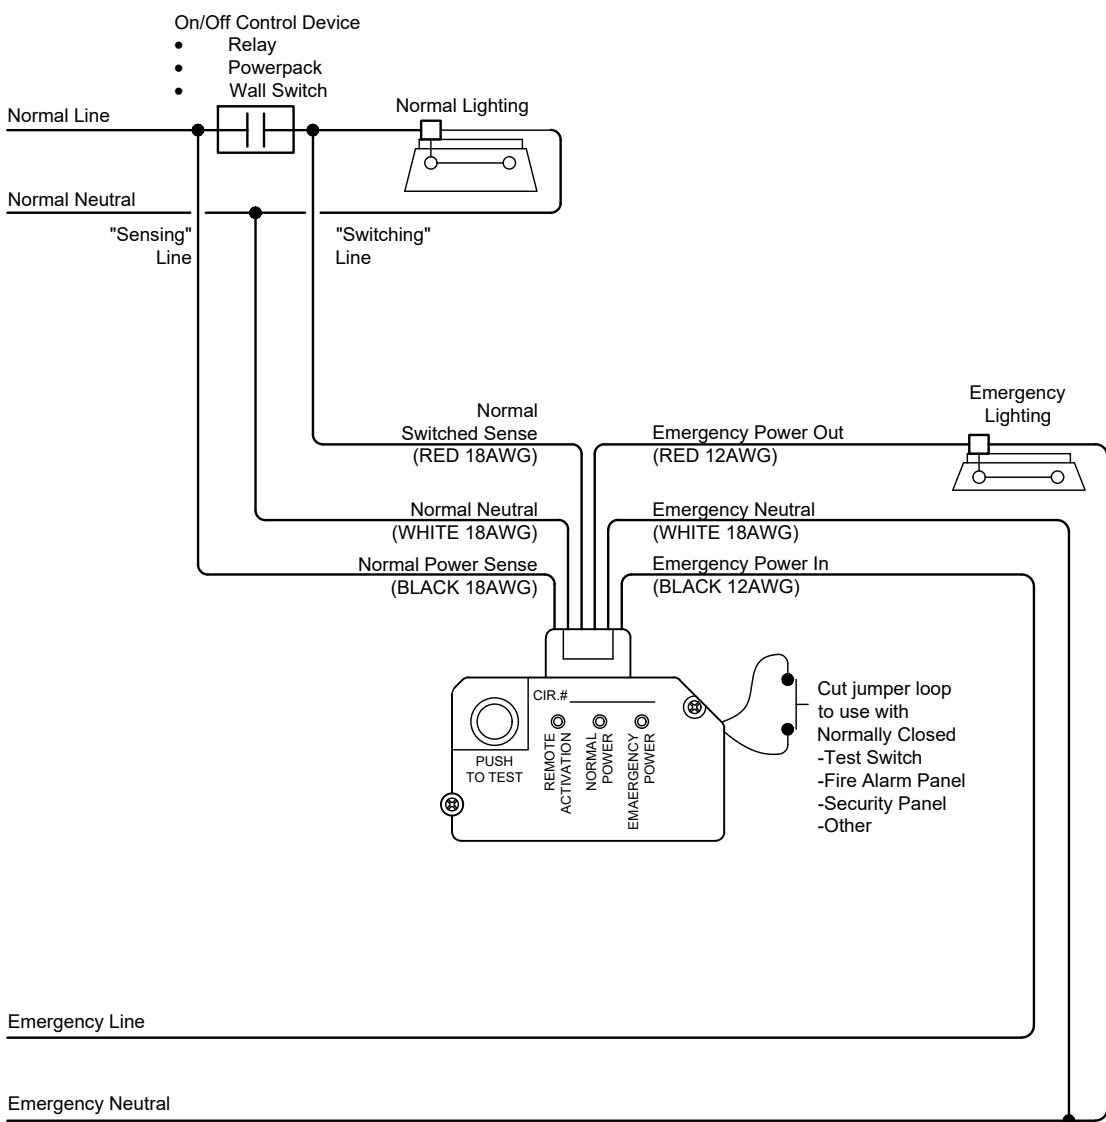

NOTES:

- (N-1) ELECTRICAL CONTRACTOR TO SUPPLY AND INSTALL UL924 LISTED EMERGENCY LIGHTING CONTROL UNIT (ELCU) TO BE MODEL WATTSTOPPER ELCU-200 OR APPROVED EQUAL. UPON LOSS OF NORMAL POWER UNIT SHALL TURN ON LIGHT FIXTURES ON EMERGENCY CIRCUIT TO FULL BRIGHTNESS.
- (N-2) TEST SWITCHES ON FACE OF INDIVIDUAL ELCU UNITS OPERATE ONLY INDIVIDUAL UNITS. REMOTE INPUTS (FIRE ALARM, TEST, ETC.) WHERE IDENTIFIED ON THE DRAWINGS ARE TO OPERATE ALL ELCU UNITS WIRED IN PARALLEL.
- (N-3) PROVIDE MAIN FIRE ALARM TIE-IN CONNECTION TO REMOTE INPUT. UPON ACTIVATION OF FIRE ALARM, SWITCHES/OCCUPANCY SENSORS TO BE BYPASSED AND ALL EMERGENCY LIGHTING TO TURN ON FULL BRIGHT.
- (N-4) REFER TO PLANS FOR QUANTITIES AND LOCATIONS OF EMERGENCY LIGHTING FIXTURES TO HAVE ON/OFF CONTROL. CONTRACTOR IS RESPONSIBLE FOR DETERMINING EXACT WIRING REQUIREMENTS WITH MANUFACTURER.

9 EMERGENCY SHUNT UNIT FOR EMERGENCY LIGHT FIXTURES

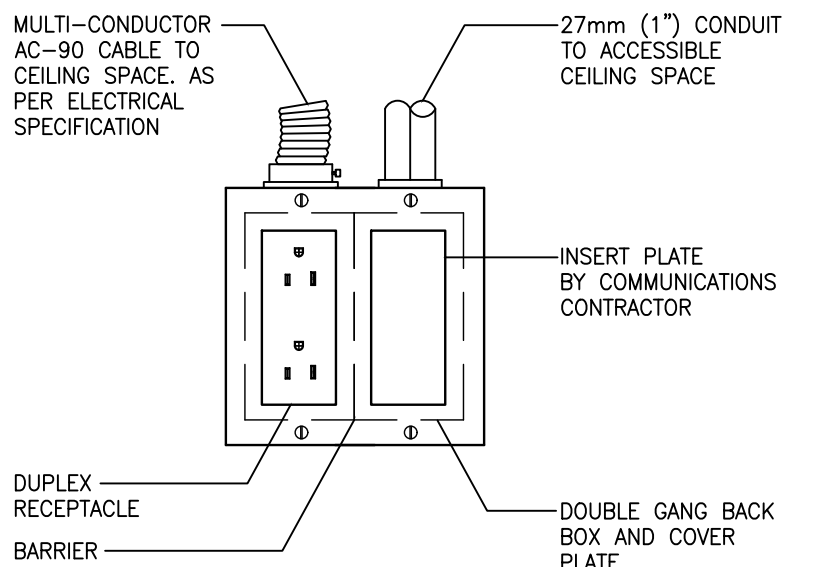

DRAWING SYMBOLS



NOTES:

- (N-1) PROVIDE CONNECTOR, C/W NYLON BUSHINGS FOR CONDUIT TERMINATIONS WITHIN ACCESSIBLE CEILING SPACE.
- (N-2) PROVIDE PULL STRINGS IN ALL EMPTY CONDUIT.
- (N-3) COVER PLATES BY ELECTRICAL CONTRACTOR

7 POWER AND COMMUNICATION OUTLETS

NOTE

PROJECT CONTACT

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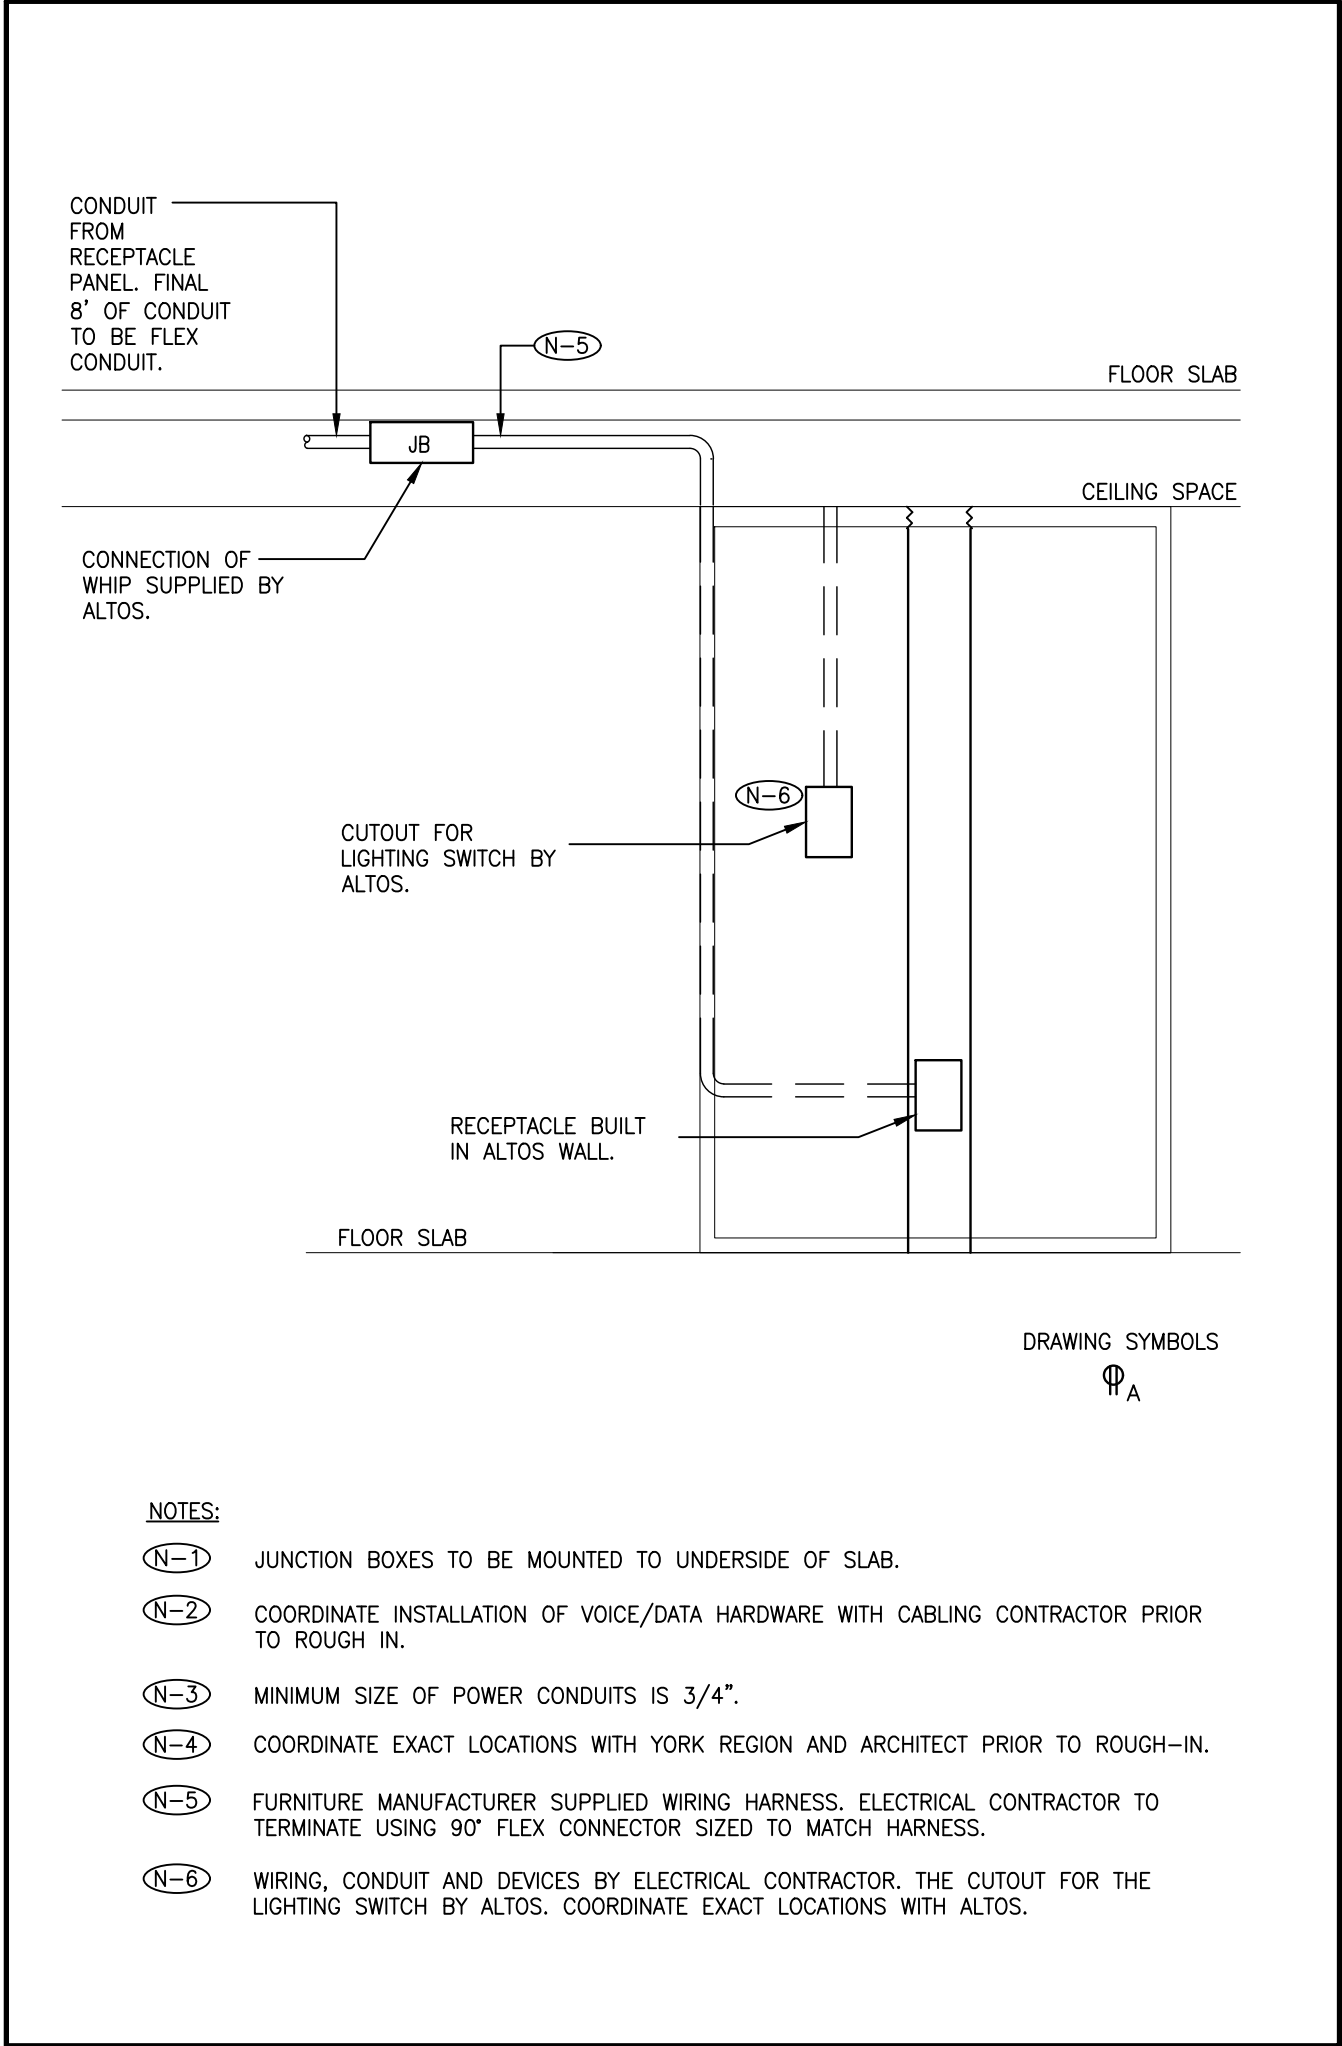
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TITLE


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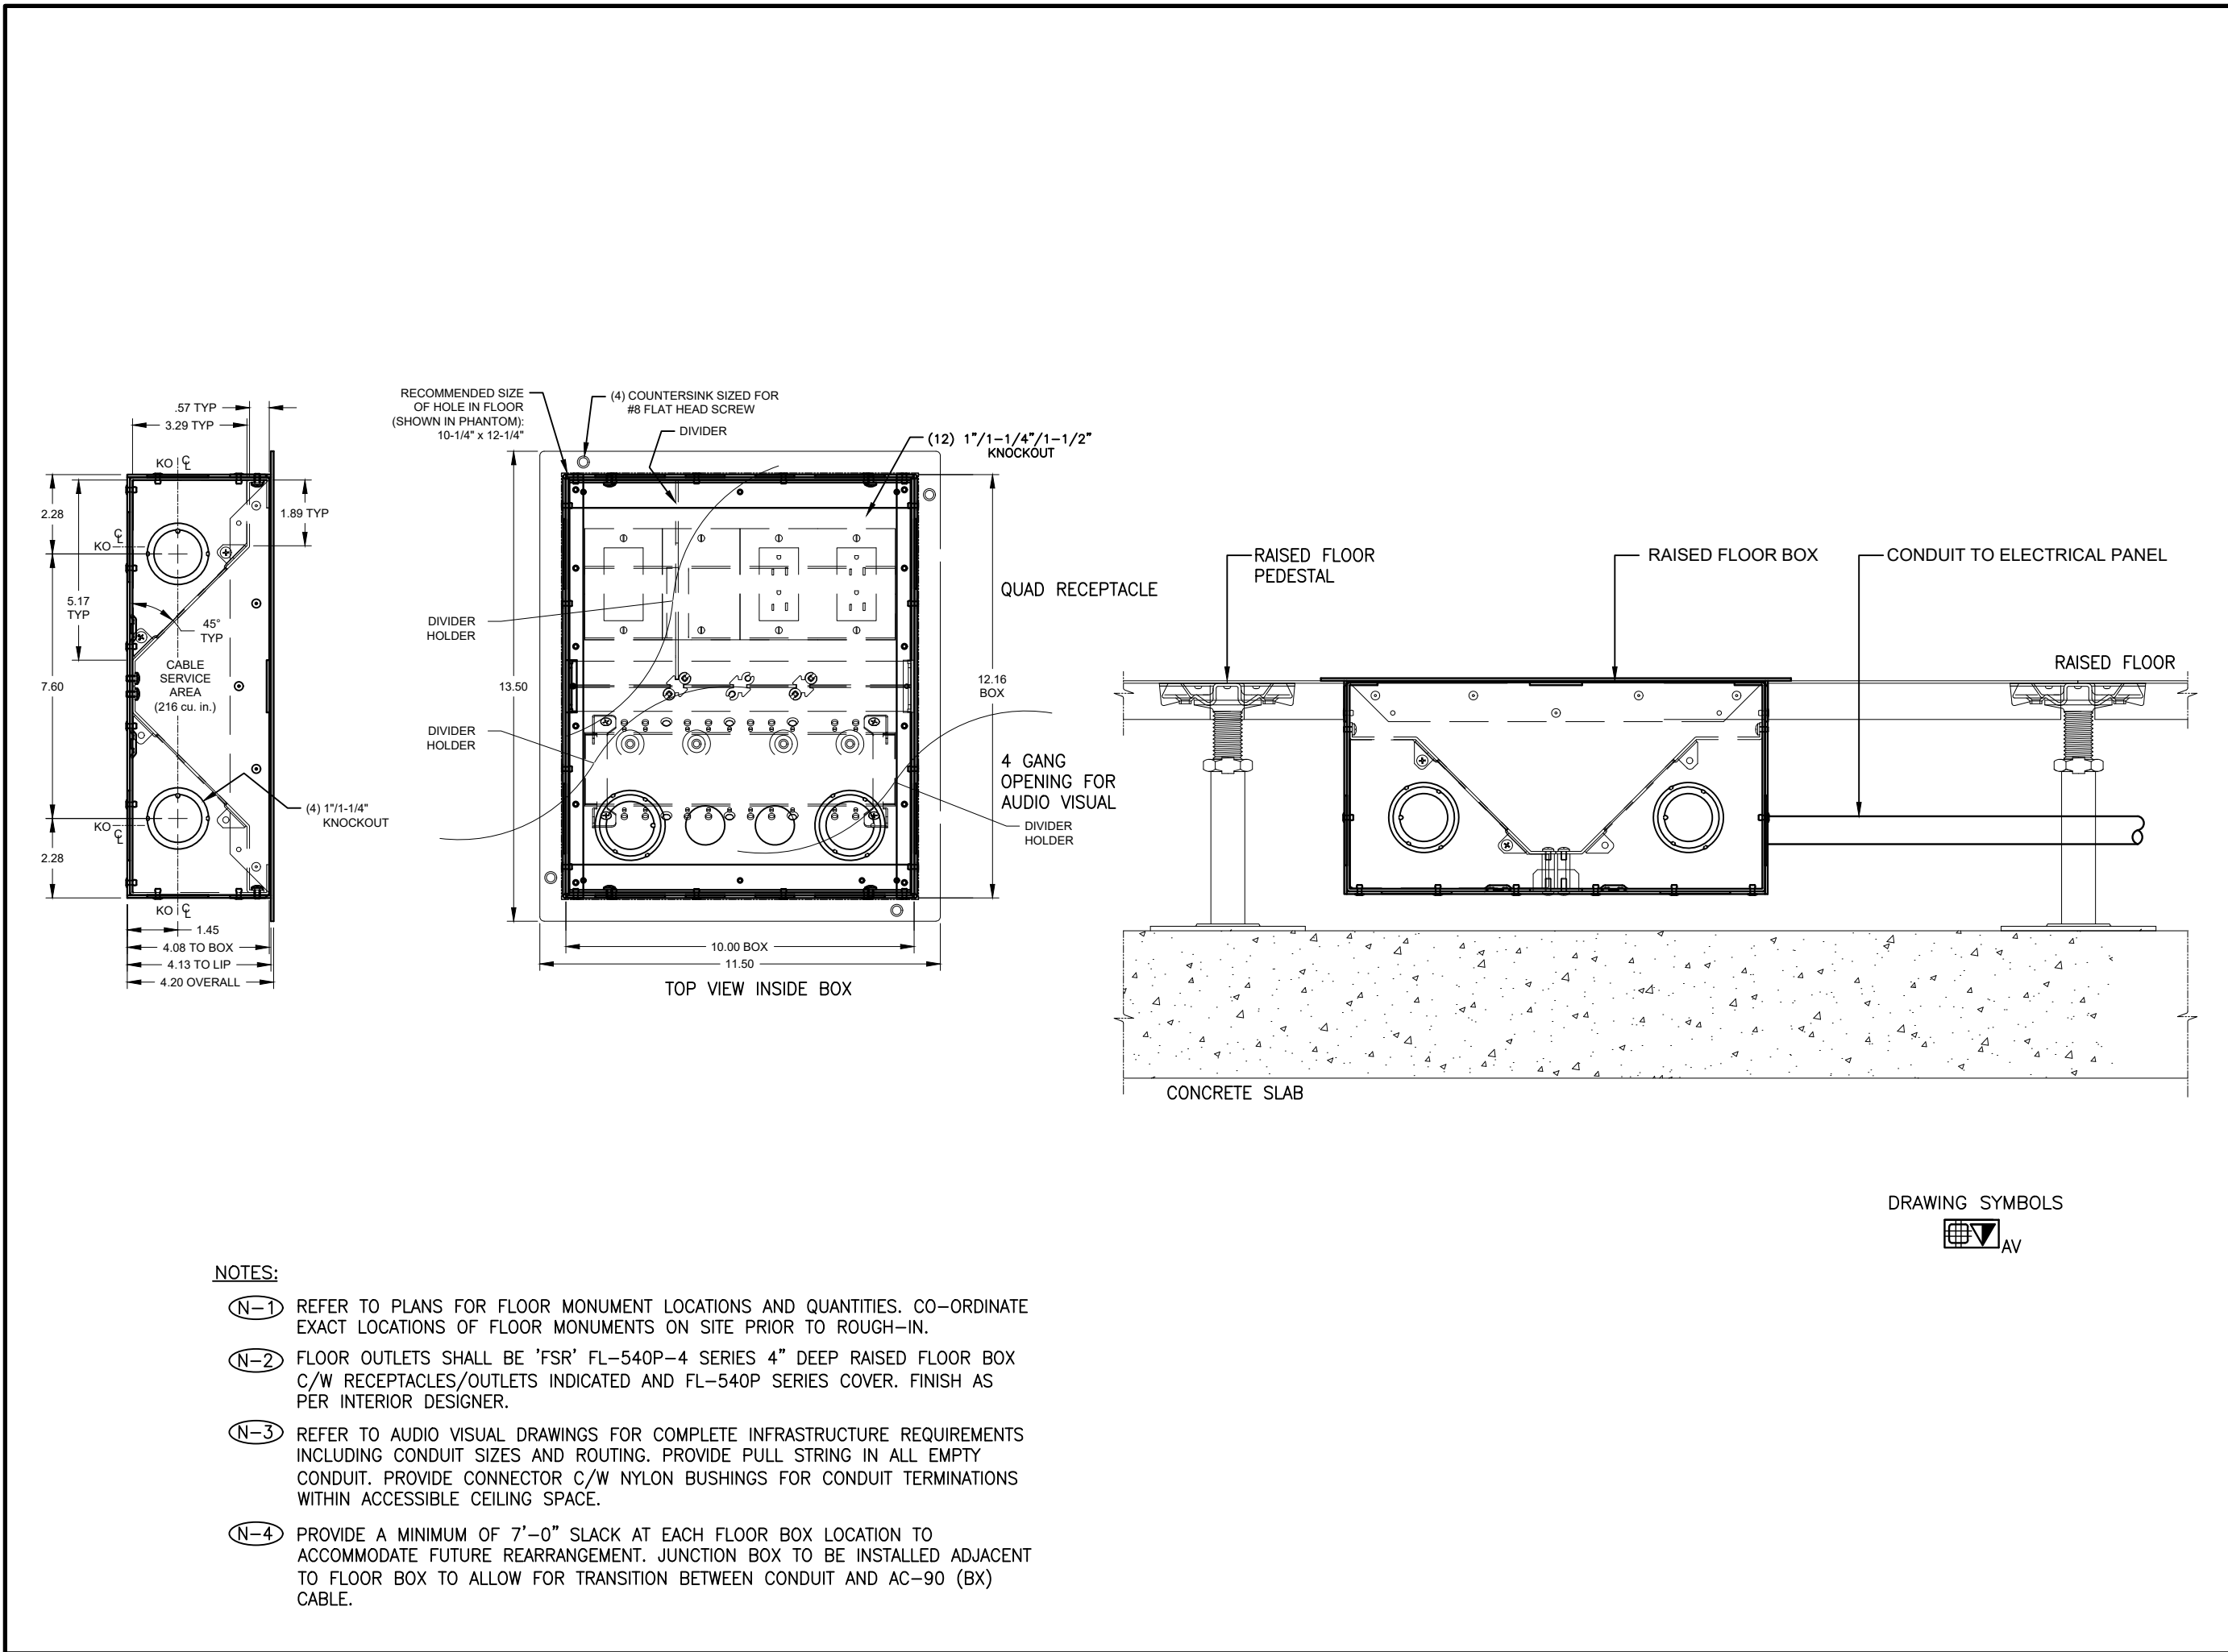
DRAWING NO. TE-0.6
SCALE N.T.S



3 ALTOS SYSTEM FURNITURE CONNECTION
TE-0.6



1 FURNITURE SYSTEM CONNECTION - WALL FEED
TE-0.6

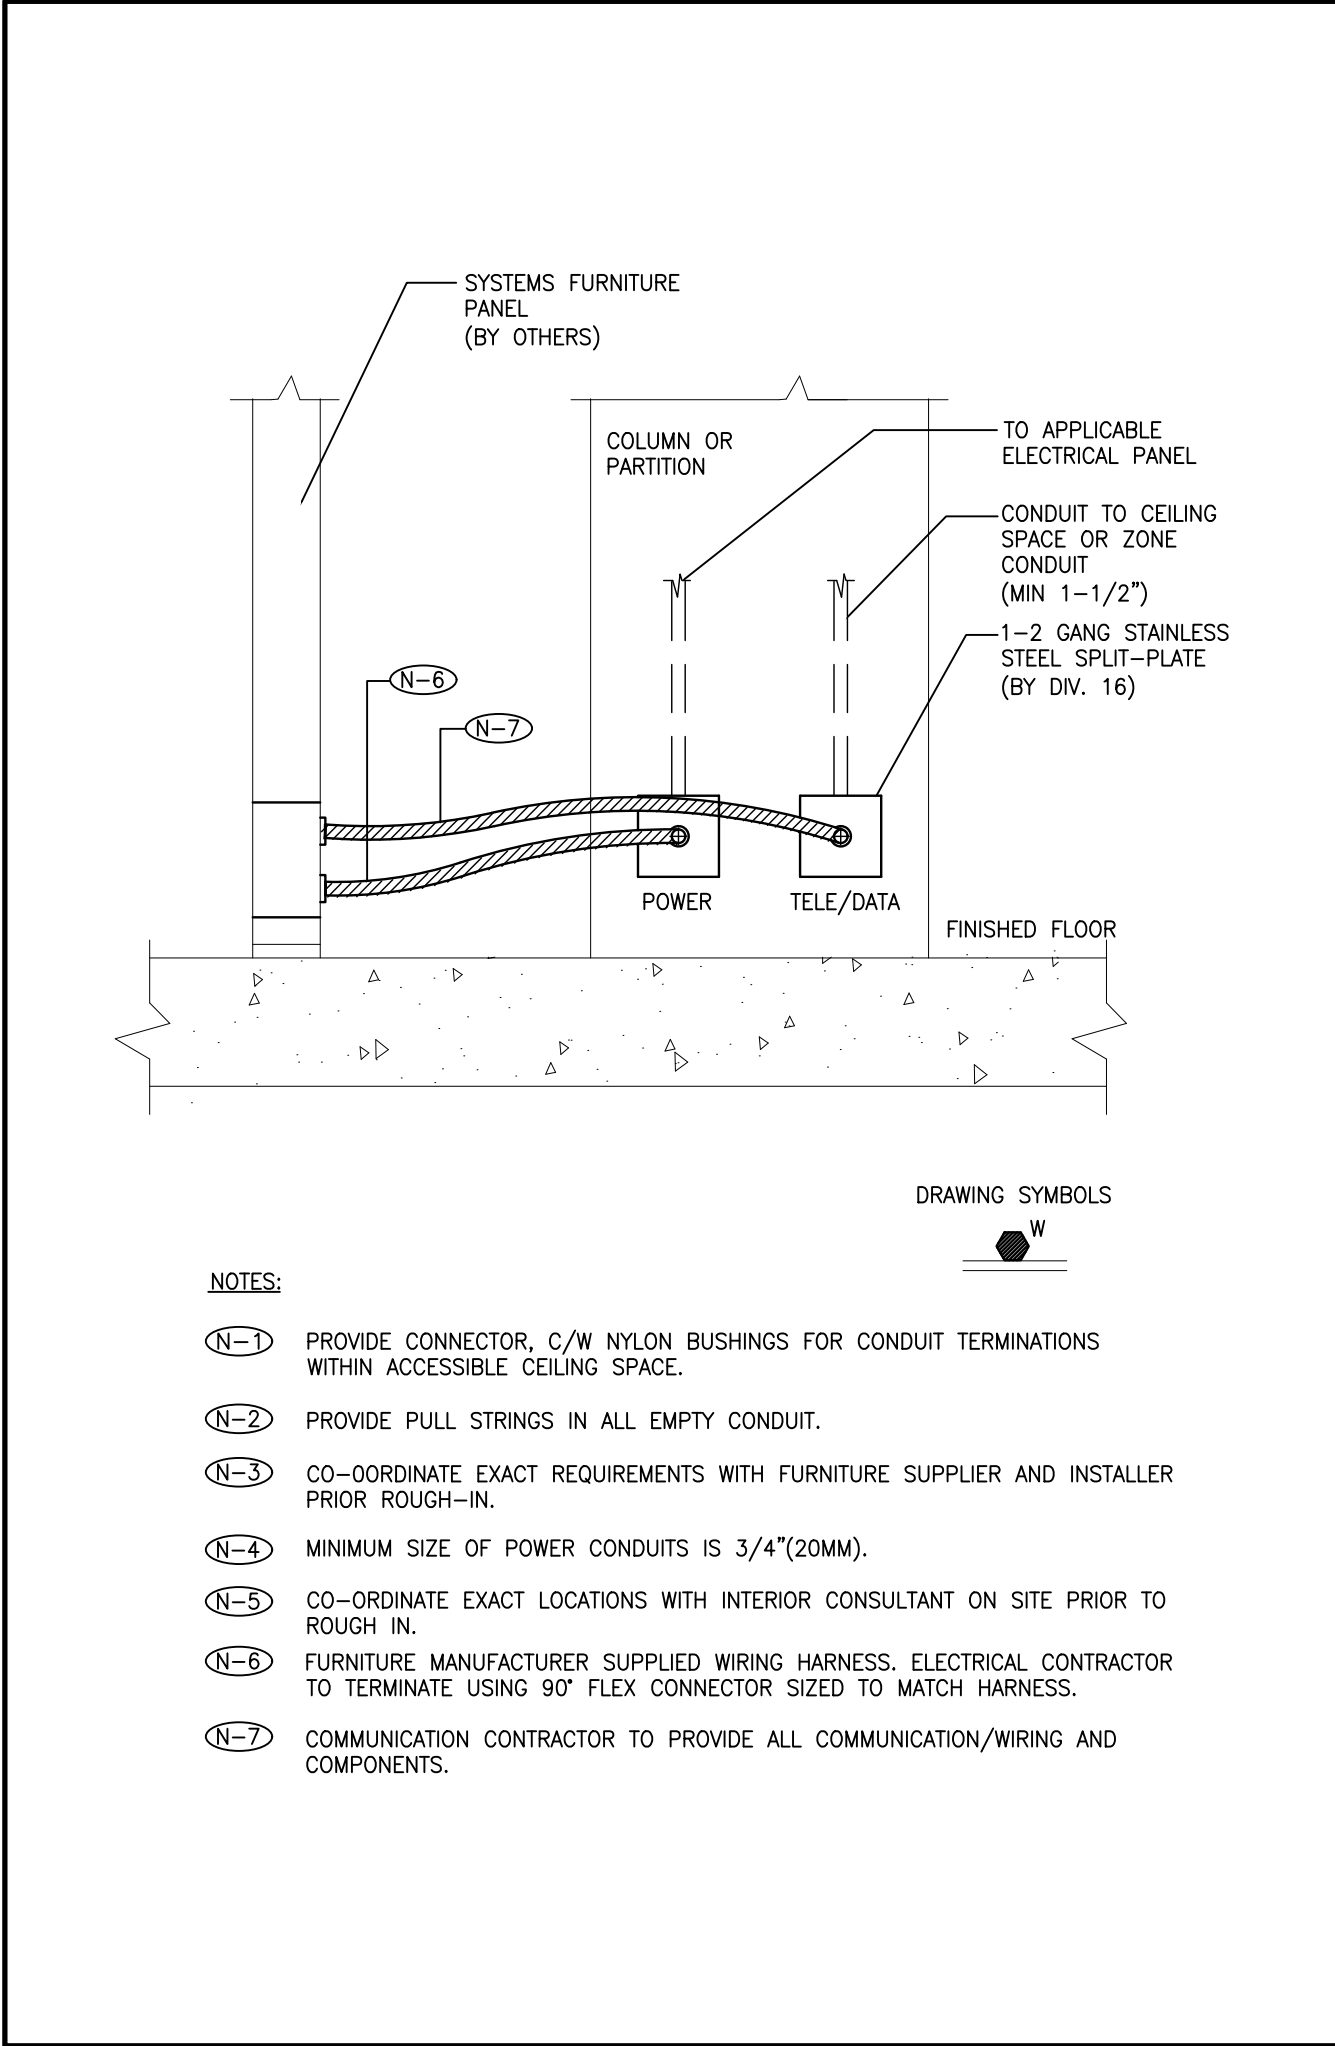

2 FLUSH RAISED FLOOR BOX DETAIL
TE-0.6



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17250 YONGE STREET, NEWMARKET, ONTARIO L3Y 4W5

TITLE

PARTIAL GROUND FLOOR LIGHTING & FIRE ALARM LAYOUT

PROJECT NO.	DRAWN	CHECKED
14008-025-E	JB	WYC/NC

DRAWING NO. **TF 1.1** SCALE **N.T.S**

TE-1.1


GENERAL NOTES:

3. THESE DRAWINGS SHALL BE READ IN CONJUNCTION WITH ARCHITECT'S DRAWINGS FOR DIMENSIONS, HEIGHTS, CONSTRUCTION DETAILING, FINISHES AND COLOURS.
2. CIRCUITING IN PART IS DIAGRAMMATIC INTENDED TO SHOW GENERAL CIRCUIT ARRANGEMENT AND PANEL DESIGNATION.
3. PROVIDE EMT CONDUIT IN AREAS WITH EXPOSED CEILINGS, BX CABLEING IS NOT ACCEPTABLE UNLESS OTHERWISE NOTED. BX CABLES MAY BE USED FOR FINAL CONNECTIONS TO LIGHTING FIXTURES OR EQUIPMENT WITH A MAXIMUM HORIZONTAL RUN OF 10 METERS. PROVIDE 100% REPEAT VERIFICATION FOR EACH CIRCUIT, FINAL, BACKGROUNDS, MOUNT EXIT SIGNS, OCCUPANCY SENSORS, EXIT SIGNS, CAMERAS, WAPS AND ALL OTHER CEILING MOUNTED DEVICES WITH STEMS SUCH THAT THEY ARE ON THE SAME PLANE AS SUSPENDED LIGHTING FIXTURES. COORDINATE CEILINGS AND WALL HEIGHTS WITH INTERIOR DESIGNER DRAWINGS.
4. REFER TO LIGHTING LAYOUT SHOWN FOR FINAL LOCATION ONLY. VISIT THE SITE AND VERIFY EACH QUANTITY AND UNITS. RELOCATE OR TO NEW, RELOCATED AND/OR RETAINED IN EXISTING LOCATION, PROVIDE NEW LUMINAIRES TO MATCH EXISTING WHERE INSUFFICIENT QUANTITY EXIST TO SUIT. ALL RELOCATED LUMINAIRES SHALL HAVE WIRING EXTENDED TO SUIT NEW LOCATION. OFFER ALL RELOCATED LUMINAIRES TO LANDLORD AND TURN OVER ALL SELECTED LUMINAIRES AT A PLACE DESIGNATED BY LANDLORD. DISPOSE OF ALL LUMINAIRES REJECTED BY LANDLORD.
5. ALL NEW/RELOCATED BASE BUILDING STANDARD LUMINAIRES AND NEW RECESSED DOWN LIGHTS SHALL BE CHAIN HUNG AND SUPPORTED FROM THE SLAB ABOVE. PROVIDE LETTER TO BE INCLUDED AS PART OF CLOSE-OUT DOCUMENT SUBMITTAL PACKAGE.
6. RELAMP EXISTING AND RELOCATED LUMINAIRES DUE TO BURNOUT CONDITIONS AND REPLACE FAULTY BALLASTS AS REQUIRED, INCLUDE IN BASE PRICE.
7. REWORK EXISTING EMERGENCY LIGHTING TO ACHIEVE NEW EMERGENCY LIGHTING AS SHOWN. CONNECT NEW AND/OR RELOCATED LUMINAIRES TO NEAREST EMERGENCY LIGHTING CIRCUITS ON THIS FLOOR, PROVIDE 347-120V LIGHTING TRANSFORMERS AS REQUIRED. IF NEW EMERGENCY BRANCH CIRCUITS ARE REQUIRED FOR EMERGENCY LIGHTING AND EXISTING EMERGENCY LIGHTING PANEL IS LOCATED ON A DIFFERENT STORY (I.E. NOT LOCATED ON SAME FLOOR), THEN NEW BRANCH CIRCUIT WIRING SHALL BE 2-HOUR FIRE RATED (I.E. NMU/MBX/ETC TO WRITTEN EMERGENCY LIGHT FED, IF EXISTING EMERGENCY LIGHTING PANEL IS LOCATED ON THE SAME STORY, THE NEW BRANCH CIRCUIT WIRING DOES NOT NEED TO BE FIRE RATED. PROVIDE LOCK-ON BREAKERS TO SUIT.
8. MEASURE THE ILLUMINATION OF THE FLOOR AT NIGHT WITH EMERGENCY LIGHTING ON ONLY, AND SEND A DRAWING SHOWING THE MAXIMUM AND MINIMUM LEVEL OF ILLUMINATION TO BE CONSIDERED FOR THE PROJECT. PROVIDE WRITTEN CONFIRMATION THAT EMERGENCY LIGHTING HAS BEEN INSTALLED IN ACCORDANCE WITH CONTRACT DOCUMENTS AND LATEST EDITION OF THE ONTARIO BUILDING CODE SECTIONS 3.2.7.3 AND 3.2.7.4. LETTER TO BE INCLUDED AS PART OF CLOSE-OUT DOCUMENT SUBMITTAL PACKAGE.
9. PROVIDE NEW PICTOGRAM (RUNNING MAN) TYPE EXIT SIGNS, FACES AND INDICATOR BASE BUILDING FIRE ALARM CONTRACTOR AND VENDOR/MANUFACTURER. BASE BUILDING FIRE ALARM CONTRACTOR/VENDOR/MANUFACTURER IS RESPONSIBLE TO ENSURE THAT ALL ADDITIONAL COMPONENTS (MATRIAL, SOFTWARE, INCLUDING ANY LABOUR TO INSTALL OR MODIFY FIRE ALARM DEVICES) ARE INCLUDED FOR BASED ON ISSUED DRAWINGS. ELECTRICAL CONTRACTOR TO ALLOW FOR ALL ASSOCIATED WIRING TO NEW FIRE ALARM SPEAKER ARE TO MATCH EXISTING AND BE CONNECTED TO NEAREST AVAILABLE SPARE EMERGENCY ZONE CIRCUIT(S). CONNECT NEW SPEAKER TO EXISTING CIRCUITS, WHERE THERE IS SPARE CAPACITY ON EXISTING CIRCUITS. IF THERE IS NO CAPACITY ON EXISTING CIRCUIT, PROVIDE NEW FIRE ALARM CIRCUITS. ALLOW FOR ALL ASSOCIATED COSTS INCLUDING BUT NOT LIMITED TO: ASSOCIATED EQUIPMENT, DEVICES, PROGRAMMING, TESTING AND VERIFICATION TO MAKE SYSTEM OPERATIONAL AND CODE COMPLIANT. ALL FIRE ALARM VERIFICATION SHALL CONFORM TO CAN/ULC-5537 LATEST EDITION. FIRE ALARM SYSTEM SHALL BE INSTALLED IN CONFORMANCE WITH CAN/ULC-5524 LATEST EDITION.
10. LOCATE AND POSITION EXIT SIGNS SUCH THAT THEY DO NOT INTERFERE WITH ADJACENT EXIT SIGNS AND EMERGENCY LIGHTING COVERAGE.
11. ALL MODIFICATIONS TO FIRE ALARM SYSTEM AND DEVICES TO BE COMPLETED BY BASE BUILDING FIRE ALARM CONTRACTOR AND VENDOR/MANUFACTURER. BASE BUILDING FIRE ALARM CONTRACTOR/VENDOR/MANUFACTURER IS RESPONSIBLE TO ENSURE THAT ALL ADDITIONAL COMPONENTS (MATRIAL, SOFTWARE, INCLUDING ANY LABOUR TO INSTALL OR MODIFY FIRE ALARM DEVICES) ARE INCLUDED FOR BASED ON ISSUED DRAWINGS. ELECTRICAL CONTRACTOR TO ALLOW FOR ALL ASSOCIATED WIRING TO NEW FIRE ALARM SPEAKER ARE TO MATCH EXISTING AND BE CONNECTED TO NEAREST AVAILABLE SPARE EMERGENCY ZONE CIRCUIT(S). CONNECT NEW SPEAKER TO EXISTING CIRCUITS, WHERE THERE IS SPARE CAPACITY ON EXISTING CIRCUITS. IF THERE IS NO CAPACITY ON EXISTING CIRCUIT, PROVIDE NEW FIRE ALARM CIRCUITS. ALLOW FOR ALL ASSOCIATED COSTS INCLUDING BUT NOT LIMITED TO: ASSOCIATED EQUIPMENT, DEVICES, PROGRAMMING, TESTING AND VERIFICATION TO MAKE SYSTEM OPERATIONAL AND CODE COMPLIANT. ALL FIRE ALARM VERIFICATION SHALL CONFORM TO CAN/ULC-5537 LATEST EDITION. FIRE ALARM SYSTEM SHALL BE INSTALLED IN CONFORMANCE WITH CAN/ULC-5524 LATEST EDITION.
12. ENSURE THAT ALL LIGHTING FIXTURES ARE CLEAN AND ILLUMINATED BY END OF PROJECT.
13. ENSURE EXISTING FIXTURES OUTSIDE OF THE SCOPE OF WORK FED FROM EXISTING CIRCUITS THAT ARE DISCONNECTED AS PART OF THE DEMOLITION SCOPE ARE RECONNECTED TO EXISTING LIGHTING CIRCUITS. CONTRACTOR TO PROVIDE ADDITIONAL CIRCUITS WHERE REQUIRED. NEW LOW VOLTAGE SWITCH ARRANGEMENT TO BE ADDED TO EXISTING CIRCUITS. PROVIDE NEW CIRCUITS AND REWIRING TO SUIT NEW LAYOUT. ALL LIGHTING, INCLUDING EMERGENCY, WITHIN THE TENANT PREMISES TO BE ON A SEPARATE LIGHTING ZONE AND TO BE CONTROLLED BY BASE BUILDING LIGHTING CONTROL. PROVIDE NEW CIRCUITS AND REWIRING TO SUIT NEW CONTRACTORS, RELAY PANELS, AND DRY INTERFACES REQUIRED FOR EACH CONTRACTOR. INCLUDE COST IN THIS CONTRACT.
14. LIGHTING FIXTURES IDENTIFIED AS EMERGENCY ARE TO BE CONNECTED SO THAT UNDER NORMAL CONDITIONS THEY WORK IN CONJUNCTION WITH THE SWITCHING AS IDENTIFIED. IN THE EVENT OF AN EMERGENCY, THESE LIGHTS ARE TO BE FORCED INTO THE "ON" POSITION. USE OF 100% REPEAT VERIFICATION FOR EACH DEVICE. THE REAY IS TO ACTIVATE THE LIGHTS TO FULL BRIGHTNESS. REFER TO DETAIL 7/TE-0.6 FOR REQUIREMENTS.
15. COORDINATE INSTALLATION OF FIXTURES WITH MECHANICAL EQUIPMENT, ELECTRICAL EQUIPMENT, SPRINKLERS AND DUCT WORK WITH OTHER TRADES PRIOR TO WORK COMMENCING.
16. ALL CEILING MOUNTED OCCUPANCY SENSORS PROVIDED AS PART OF THIS SCOPE OF WORK MUST BE LOCATED AT LEAST 6" AWAY FROM ANY SUPPLY AIR DIFFUSER AND RETURN AIR GRILLE AS PER MANUFACTURER'S RECOMMENDATION. COORDINATE INSTALLATION ON SITE WITH MECHANICAL CONTRACTOR PRIOR TO COMMENCING WORK.
17. FIRE ALARM TESTING CAN ONLY BE DONE BETWEEN THE HOURS OF 7AM AND 5PM. FIRE ALARM CONTRACTOR TO PLAN FOR THIS AND SCHEDULE SITE VISITS AS REQUIRED.
18. IN ADDITION TO THE FIRE ALARM DEVICES INDICATED ON DRAWINGS, BASE BID PRICE SHALL INCLUDE FOR PROVISION (SUPPLY AND INSTALL) OF AN ADDITIONAL THREE (3) FIRE ALARM SPEAKER/STROBE FOR THIS FLOOR COMPLETE WITH 30-0" CONDUIT AND WIRING (PER DEVICE), PROGRAMMING, TESTING AND VERIFICATION TO MAKE SYSTEM OPERATIONAL AND CODE COMPLIANT. PROVIDE 100% REPEAT VERIFICATION FOR EACH DEVICE. POST CITY FIRE DEPARTMENT INSPECTION.
19. ONCE THE THERMOSTAT OVERRIDE BUTTON IS PRESSED, THE LIGHTING SYSTEM IS TO ACTIVATE THE HALLWAY LIGHTING. COORDINATE LOCATION OF THERMOSTAT WITH MECHANICAL

DRAWING NOTES:

(N-1) ALL FIXTURES ARE TYPE "L1" UNLESS OTHERWISE NOTED. TYPE

(N-2) FINAL LOCATION OF POTLIGHTS TO BE COORDINATED ON-SITE. TYPE

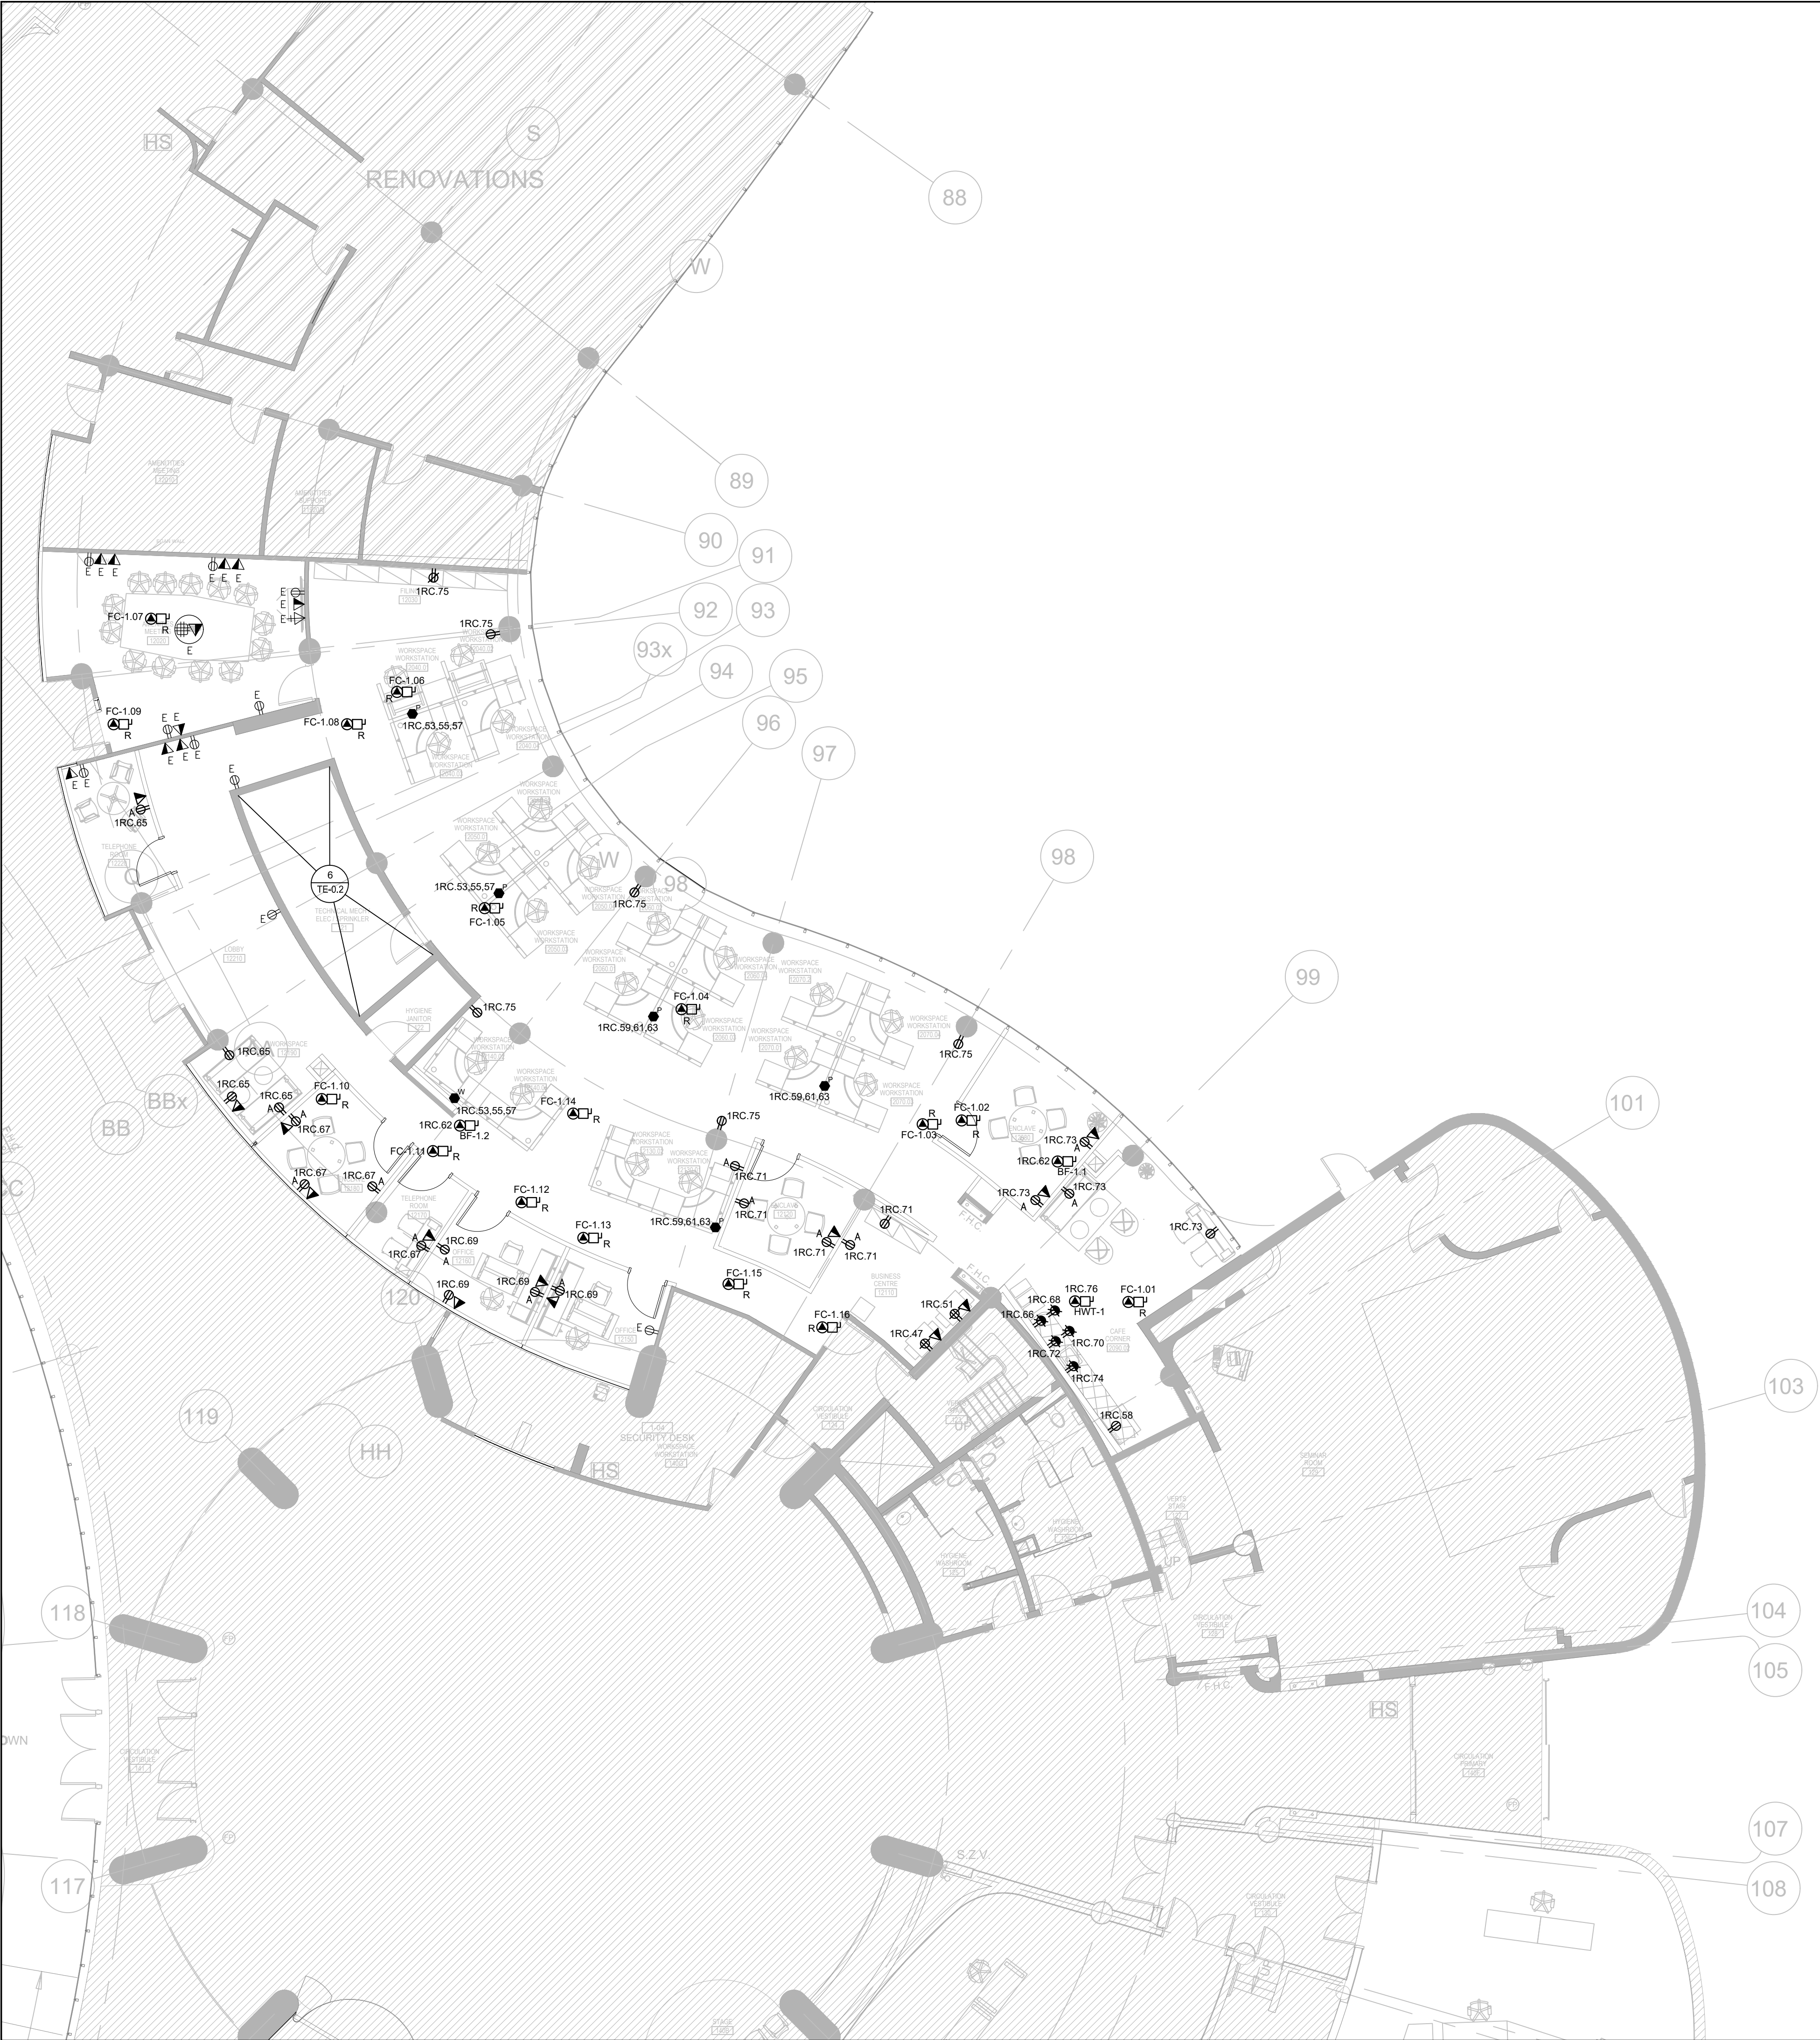

- GENERAL NOTES:
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 3. PROVIDE EMT CONDUIT IN AREAS WITH EXPOSED CEILINGS. BX CABLING IS NOT ACCEPTABLE UNLESS OTHERWISE NOTED. BX CABLES MAY BE USED FOR FINAL CONNECTIONS TO LIGHTING FIXTURES OR EQUIPMENT WITH A MAXIMUM HORIZONTAL RUN LENGTH OF 3 FEET / 1 METER. PAINT CONDUITS TO MATCH ARCHITECTURAL BACKGROUNDS. MOUNT EXIT SIGNS, OCCUPANCY SENSORS, EXIT SIGNS, CAMERAS, WAPS AND ALL OTHER CEILING MOUNTED DEVICES WITH STEMS SUCH THAT THEY ARE ON THE SAME PLANE AS SUSPENDED LIGHTING FIXTURES. COORDINATE CEILINGS AND WALL HEIGHTS WITH INTERIOR DESIGNER DRAWINGS.
 4. REUSE CIRCUITS OBTAINED THROUGH DEMOLITION IS ACCEPTABLE.
 5. VERIFY EXACT POWER REQUIREMENTS AND RECEPTACLE TYPES FOR SPECIAL EQUIPMENT WITH MANUFACTURER PRIOR TO INSTALLATION. PROVIDE HARDWARE CONNECTIONS FOR DISHWASHERS AND COPIERS ETC. IN LIEU OF RECEPTACLES OR VICE VERSA, AS REQUIRED.
 6. REFER TO ARCHITECT DRAWINGS FOR THE COLOUR OF COVERPLATES AND MOUNTING HEIGHTS.
 7. MARK UP OUTLET AND DEVICE LOCATIONS AND OBTAIN APPROVAL BY DESIGN CONSULTANT PRIOR TO INSTALLATION.
 8. PROVIDE SUITABLE LABELS ON ALL RECEPTACLES AND SYSTEM FURNITURE FEEDS. LABELS TO INCLUDE BOTH PANEL AND CIRCUIT DESIGNATION. REVIEW LABEL SIZE AND TYPE WITH CONSULTANT PRIOR TO INSTALLATION.
 9. TRACE ALL EXISTING OUTLETS, NOTED AS EXISTING, AND IDENTIFY ON AS BUILT DRAWING AS PER SPECIFICATION.
 10. ALLOW FOR THE REMOVAL AND RE-INSTALLATION OF SYSTEMS FURNITURE CONNECTIONS.
 11. CONFIRM ELECTRICAL REQUIREMENTS AND EXACT LOCATION OF ALL MECHANICAL EQUIPMENT WITH MECHANICAL DRAWINGS AND CONTRACTOR PRIOR TO ROUGH-INS.
 12. ROUTE ALL CONDUIT SYSTEMS AROUND DUCT WORK, BEAMS AND PIPING AS REQUIRED TO ACCOMMODATE LAYOUT SHOWN. REFER TO MECHANICAL DRAWINGS AND ARCHITECTURAL DRAWINGS FOR ADDITIONAL DETAILS.

- DRAWING NOTES:
- (N-1) COORDINATE EXACT LOCATION & MOUNTING HEIGHT OF RECEPTACLES NOTED AS "TV" WITH YORK REGION PRIOR TO INSTALLATION, TYPICAL.
 - (N-2) RELOCATED CEILING MOUNTED FCU POWER CONNECTIONS SHOWN. ENSURE CIRCUITS ARE NOT OVERLOADED. REFER TO MECHANICAL DRAWINGS FOR FURTHER INFORMATION. TYP.



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
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PROJECT CONTACT

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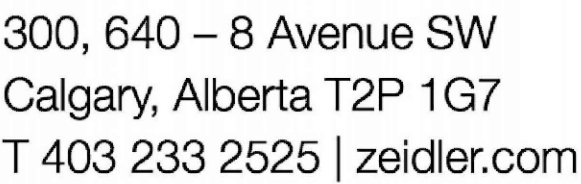
PROJECT ADDRESS
17250 YONGE STREET, NEWMARKET, ONTARIO L3Y 4W5

TITLE

PARTIAL GROUND FLOOR
POWER & SYSTEMS LAYOUT

PROJECT NO.	DRAWN	CHECKED
14008-025-E	JB	WYC/NC

DRAWING NO.	SCALE
TE-1.2	1:100



NAME: John Bei

TEL: 437-880-5404

EMAIL: john.bei@smithandandersen.com

THIS DRAWING SHALL BE READ IN CONJUNCTION WITH ELECTRICAL SPECIFICATION SUBMITTED FOR THIS PROJECT.

3.	ISSUED FOR TENDER	2026.02.24
5.	ISSUED FOR TENDER	2026.01.30
4.	ISSUED FOR PERMIT	2026.01.16
3.	ISSUED FOR 100% REVIEW	2025.11.14
2.	ISSUED FOR 90% REVIEW	2025.10.03
1.	ISSUED FOR 60% REVIEW	2025.06.27
NO.	ISSUED/REVISION	DATE



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PROJECT
YORK REGION
MUNICIPALITY CENTRE

PROJECT ADDRESS
17250 YONGE STREET, NEWMARKET, ONTARIO L3Y 4W5

PARTIAL GROUND FLOOR LIGHTING & FIRE ALARM DEMOLITION LAYOUT

PROJECT NO.	DRAWN	CHECKED
14008-025-E	JB	WYC/NC

DRAWING NO. **TF 10** SCALE **1:100**

TE-1.3



- GENERAL NOTES:
1. REFER TO THE ARCHITECT'S DRAWINGS TO DETERMINE COMPLETE EXTENT OF DEMOLITION AND ALLOW FOR ALL COSTS. COMPLETE EXTENT OF DEMOLITION IS NOT SHOWN.
 2. REMOVE ALL FLOOR, COLUMN, CEILING, AND WALL MOUNTED POWER, TELEPHONE/DATA OUTLETS, CABLING AND CONDUIT NOT REQUIRED, TO SUIT NEW LAYOUT AND MAKE SAFE. VISIT SITE TO DETERMINE EXACT REQUIREMENTS AND REFER TO DEMOLITION DRAWINGS.
 3. MAKE GOOD ALL CORE HOLES FROM ELECTRICAL EQUIPMENT AND DEVICES DISCONNECTED, RELOCATED AND OR REMOVED IN THIS PROJECT.
 4. REMOVE FLOOR MONUMENT(S) AND ALL ASSOCIATED CONDUIT(S) AND WIRE BACK TO SOURCE. MAKE GOOD ALL FLOOR PENETRATIONS TO COMPLY WITH CURRENT LOCAL APPLICABLE CODES.
 5. COORDINATE ALL WORK TO SUIT PROJECT PHASE SCHEDULE. COORDINATE PHASING WITH ARCHITECT/INTERIOR DESIGN/GC DRAWINGS. PHASING IF SHOWN IS FOR REFERENCE PURPOSES ONLY.
 6. EXISTING CONDITIONS SHOWN ARE BASED ON DRAWINGS, FIELD SURVEY AND INFORMATION PROVIDED BY LANDLORD. ELECTRICAL CONTRACTOR TO FIELD VERIFY ALL EXISTING CONDITIONS PRIOR TO BIDDING. ANY DISCREPANCIES BETWEEN EXISTING CONDITIONS AND THOSE SHOWN HERE SHALL BE BROUGHT TO THE ATTENTION OF THE PROJECT MANAGER PRIOR TO BIDDING.
 7. NO ADDITIONAL COST WILL BE APPROVED FOR ANY REVISIONS/MODIFICATIONS REQUIRED BY ANY TRADE OR CONTRACTOR DUE TO THE LACK OF COORDINATION BETWEEN TRADES AND CONTRACTORS.
 8. COORDINATE WITH GENERAL CONTRACTOR AND LANDLORD FOR DISPOSAL OF ALL MATERIALS FROM SITE.

DRAWING NOTES:

(N-1) EX. CEILING MOUNTED FCU POWER CONNECTIONS TO BE RELOCATED AS REQUIRED, TYP.



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NOTE

PROJECT CONTACT

NAME:	John Bei
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EMAIL:	john.bei@smithandandersen.com

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NO.	ISSUED/REVISION DATE



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PROJECT
YORK REGION
MUNICIPALITY CENTRE

PROJECT ADDRESS
17250 YONGE STREET, NEWMARKET, ONTARIO L3Y 4W5

TITLE

PARTIAL GROUND FLOOR
POWER & SYSTEMS
DEMOLITION LAYOUT

PROJECT NO.	DRAWN	CHECKED
14008-025-E	JB	WYC/NC

DRAWING NO.	SCALE
TE-1.4	1:100

NOTE

PROJECT CONTACT

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PROJECT

YORK REGION
MUNICIPALITY CENTRE

PROJECT ADDRESS

17250 YONGE STREET, NEWMARKET, ONTARIO L3Y 4W5

TITLE

PARTIAL SECOND FLOOR
LIGHTING & FIRE ALARM
LAYOUT

PROJECT NO. 14008-025-E
DRAWN JB
CHECKED WYC/NC


DRAWING NO. TE-2.1A
SCALE 1:100


GENERAL NOTES:

- THESE DRAWINGS SHALL BE READ IN CONJUNCTION WITH ARCHITECT'S DRAWINGS FOR DIMENSIONS, HEIGHTS, CONSTRUCTION DETAILING, FINISHES AND COLOURS.
- CIRCUITING IN PART IS DIAGRAMMATIC INTENDED TO SHOW GENERAL CIRCUIT ARRANGEMENT AND PANEL DESIGNATION.
- PROVIDE EMT CONDUIT IN AREAS WITH EXPOSED CEILINGS. BX CABLING IS NOT ACCEPTABLE UNLESS OTHERWISE NOTED. BX CABLES MAY BE USED FOR FINAL CONNECTIONS TO LIGHTING FIXTURES OR EQUIPMENT WITH A MAXIMUM HORIZONTAL RUN LENGTH OF 3 FEET / 1 METER. PAINT CONDUITS TO MATCH ARCHITECTURAL BACKGROUNDS. MOUNT EXIT SIGNS, OCCUPANCY SENSORS, EXIT SIGNS, CAMERAS, WAPS AND ALL OTHER CEILING MOUNTED DEVICES WITH STEMS SUCH THAT THEY ARE ON THE SAME PLANE AS SUSPENDED LIGHTING FIXTURES. COORDINATE CEILINGS AND WALL HEIGHTS WITH INTERIOR DESIGNER DRAWINGS.
- REFER TO LIGHTING LAYOUT SHOWN FOR FINAL LOCATION ONLY. VISIT THE SITE AND COORDINATE EXACT QUANTITY OF LIGHTING LUMINAIRES TO BE NEW, RELOCATED AND/OR RETAINED IN EXISTING LOCATION. PROVIDE NEW LUMINAIRES TO MATCH EXISTING WHERE INSUFFICIENT QUANTITY EXIST TO SUIT. ALL RELOCATED LUMINAIRES SHALL HAVE WIRING EXTENDED TO SUIT NEW LOCATION. OFFER ALL UNUSED EXISTING LUMINAIRES TO LANDLORD AND TURN OVER ALL SELECTED LUMINAIRES AT A PLACE DESIGNATED BY LANDLORD. DISPOSE OF ALL LUMINAIRES REJECTED BY LANDLORD.
- ALL NEW/RELOCATED BASE BUILDING STANDARD LUMINAIRES AND NEW RECESSED DOWN LIGHTS SHALL BE CHAIN HUNG AND SUPPORTED FROM THE SLAB ABOVE. PROVIDE LETTER TO BE INCLUDED AS PART OF CLOSE-OUT DOCUMENT SUBMITTAL PACKAGE.
- RELAMP EXISTING AND RELOCATED LUMINAIRES DUE TO BURNOUT CONDITIONS AND REPLACE FAULTY BALLASTS AS REQUIRED. INCLUDE IN BASE PRICE.
- REWORK EXISTING EMERGENCY LIGHTING TO ACHIEVE NEW EMERGENCY LIGHTING AS SHOWN. CONNECT NEW AND/OR RELOCATED LUMINAIRES TO NEAREST EMERGENCY LIGHTING CIRCUITS ON THIS FLOOR. PROVIDE 347-120V LIGHTING TRANSFORMERS AS REQUIRED. IF NEW EMERGENCY BRANCH CIRCUITS ARE REQUIRED FOR EMERGENCY LIGHTING AND EXISTING EMERGENCY LIGHTING PANEL IS LOCATED ON A DIFFERENT STOREY (i.e. NOT LOCATED ON SAME FLOOR), THEN NEW BRANCH CIRCUIT WIRING SHALL BE 2-HOUR FIRE RATED (i.e. MI CABLE) TO FIRST EMERGENCY LIGHT FED. IF EXISTING EMERGENCY LIGHTING PANEL IS LOCATED ON THE SAME STOREY, THE NEW BRANCH CIRCUIT WIRING DOES NOT NEED TO BE FIRE RATED. PROVIDE LOCK-ON BREAKERS TO SUIT.
- MEASURE THE ILLUMINATION OF THE FLOOR AT NIGHT WITH EMERGENCY LIGHTING ON ONLY, AND SEND A DRAWING SHOWING THE MAXIMUM AND MINIMUM LEVEL OF ILLUMINATION. TO THE CONSULTING ENGINEER FOR REVIEW. PROVIDE WRITTEN CONFIRMATION THAT EMERGENCY LIGHTING HAS BEEN INSTALLED IN ACCORDANCE WITH CONTRACT DOCUMENTS AND LATEST EDITION OF THE ONTARIO BUILDING CODE SECTIONS 3.2.7.3 AND 3.2.7.4. LETTER TO BE INCLUDED AS PART OF CLOSE-OUT DOCUMENT SUBMITTAL PACKAGE.
- PROVIDE NEW PICTOGRAM (RUNNING MAN) TYPE EXIT SIGNS. FACES AND INDICATOR ARROWS AS PER DRAWINGS AND UNIVERSAL 120-347VAC VOLTAGE INPUT UNLESS OTHERWISE NOTED. CONNECT NEW EXIT SIGNS TO THE NEAREST AVAILABLE SPARE EXIT LIGHTING CIRCUIT. DO NOT OVERLOAD THE CIRCUIT. ALLOW FOR THREE (3) ADDITIONAL EXIT SIGNS (COMPLETE WITH MATERIAL AND LABOUR) TO BE INSTALLED AS PER BUILDING INSPECTORS REQUIREMENTS UPON FINAL INSPECTION PER EACH AREA.
- LOCATE AND POSITION EXIT SIGNS SUCH THAT THEY DO NOT INTERFERE WITH ADJACENT EXIT SIGNS AND EMERGENCY LIGHTING COVERAGE.
- ALL MODIFICATIONS TO FIRE ALARM SYSTEM AND DEVICES TO BE COMPLETED BY BASE BUILDING FIRE ALARM CONTRACTOR AND VENDOR/MANUFACTURER. BASE BUILDING FIRE ALARM CONTRACTOR/VENDOR/MANUFACTURER IS RESPONSIBLE TO ENSURE THAT ALL ADDITIONAL COMPONENTS (MATERIAL, SOFTWARE, INCLUDING LABOUR TO INSTALL OR MODIFY FIRE ALARM DEVICES) ARE INCLUDED FOR BASED ON ISSUED DRAWINGS. ELECTRICAL CONTRACTOR TO ALLOW FOR ALL ASSOCIATED COSTS. NEW FIRE ALARM SPEAKER ARE TO MATCH EXISTING AND BE CONNECTED TO NEAREST AVAILABLE SPARE EMERGENCY ZONE CIRCUIT(S). CONNECT NEW SPEAKER TO EXISTING CIRCUITS, WHERE THERE IS SPARE CAPACITY ON RESPECTIVE CIRCUITS. IF THERE IS NO CAPACITY ON EXISTING CIRCUITS, PROVIDE NEW FIRE ALARM CIRCUITS. ALLOW FOR ALL ASSOCIATED COSTS INCLUDING BUT NOT LIMITED TO: ASSOCIATED EQUIPMENT, DEVICES, PROGRAMMING, TESTING AND VERIFICATION TO MAKE SYSTEM OPERATIONAL AND CODE COMPLIANT. ALL FIRE ALARM VERIFICATION SHALL CONFORM TO CAN/ULC-S537 LATEST EDITION. FIRE ALARM SYSTEM SHALL BE INSTALLED IN CONFORMANCE WITH CAN/ULC-SS24 LATEST EDITION.
- ENSURE THAT ALL LIGHTING FIXTURES ARE CLEAN AND ILLUMINATED BY END OF PROJECT.
- ENSURE EXISTING FIXTURES OUTSIDE OF THE SCOPE OF WORK FED FROM EXISTING CIRCUITS THAT ARE DISCONNECTED AS PART OF THE DEMOLITION SCOPE ARE RECONNECTED TO EXISTING LIGHTING CIRCUITS. CONTRACTOR TO PROVIDE ADDITIONAL CIRCUITS WHERE REQUIRED. NEW LOW VOLTAGE SWITCH ARRANGEMENT OF LIGHTING TO BE CO-ORDINATED WITH LANDLORD AND REARRANGED TO SUIT NEW LAYOUT. ALL LIGHTING, EXCLUDING EMERGENCY, WITHIN THE TENANT PREMISES TO BE ON A SEPARATE LIGHTING ZONE AND TO BE CONTROLLED BY BASE BUILDING LIGHTING CONTROL SYSTEM. PROVIDE ALL NECESSARY RELAYS, CONTACTORS, RELAY PANELS, AND DRY INTERFACES REQUIRED FOR SUCH CONTROL. INCLUDE COST IN THIS CONTRACT.
- LIGHTING FIXTURES IDENTIFIED AS EMERGENCY ARE TO BE CONNECTED SO THAT UNDER NORMAL CONDITIONS THEY WORK IN CONJUNCTION WITH THE SWITCHING AS IDENTIFIED. IN THE EVENT OF AN EMERGENCY, THESE LIGHTS ARE TO BE FORCED ON WITH THE USE OF A UL-924 LISTED RELAY. UPON POWER FAILURE THE RELAY IS TO ACTIVATE THE LIGHTS TO FULL BRIGHTNESS. REFER TO DETAIL 7/TE-0.6 FOR REQUIREMENTS.
- COORDINATE INSTALLATION OF FIXTURES WITH MECHANICAL EQUIPMENT, ELECTRICAL EQUIPMENT, SPRINKLERS AND DUCT WORK WITH OTHER TRADES PRIOR TO WORK COMMENCING.
- ALL CEILING MOUNTED OCCUPANCY SENSORS PROVIDED AS PART OF THIS SCOPE OF WORK MUST BE LOCATED AT LEAST 6"0" AWAY FROM ANY SUPPLY AIR DIFFUSER AND RETURN AIR GRILLE AS PER MANUFACTURER'S RECOMMENDATION. COORDINATE INSTALLATION ON SITE WITH MECHANICAL CONTRACTOR PRIOR TO COMMENCING WORK.
- FIRE ALARM TESTING CAN ONLY BE DONE BETWEEN THE HOURS OF 7AM AND 8AM. FIRE ALARM CONTRACTOR TO PLAN FOR THIS AND SCHEDULE SITE VISITS AS REQUIRED.
- IN ADDITION TO THE FIRE ALARM DEVICES INDICATED ON DRAWINGS, BASE BID PRICE SHALL INCLUDE FOR PROVISION (SUPPLY AND INSTALL) OF AN ADDITIONAL THREE (3) FIRE ALARM SPEAKER/STROBE FOR THIS FLOOR COMPLETE WITH 30'-0" CONDUIT AND WIRING (PER DEVICE), PROGRAMMING, TESTING AND CERTIFICATION, LABELING AND 100% REPEAT VERIFICATION FOR EACH DEVICE POST CITY FIRE DEPARTMENT INSPECTION.
- ONCE THE THERMOSTAT OVERRIDE BUTTON IS PRESSED, THE LIGHTING SYSTEM IS TO ACTIVATE THE HALLWAY LIGHTING. COORDINATE LOCATION OF THERMOSTAT WITH MECHANICAL.

DRAWING NOTES:

- (N-1) ALL FIXTURES ARE TYPE "L1" UNLESS OTHERWISE NOTED. TYP
(N-2) FINAL LOCATION OF POTLIGHTS TO BE COORDINATED ON-SITE. TYP

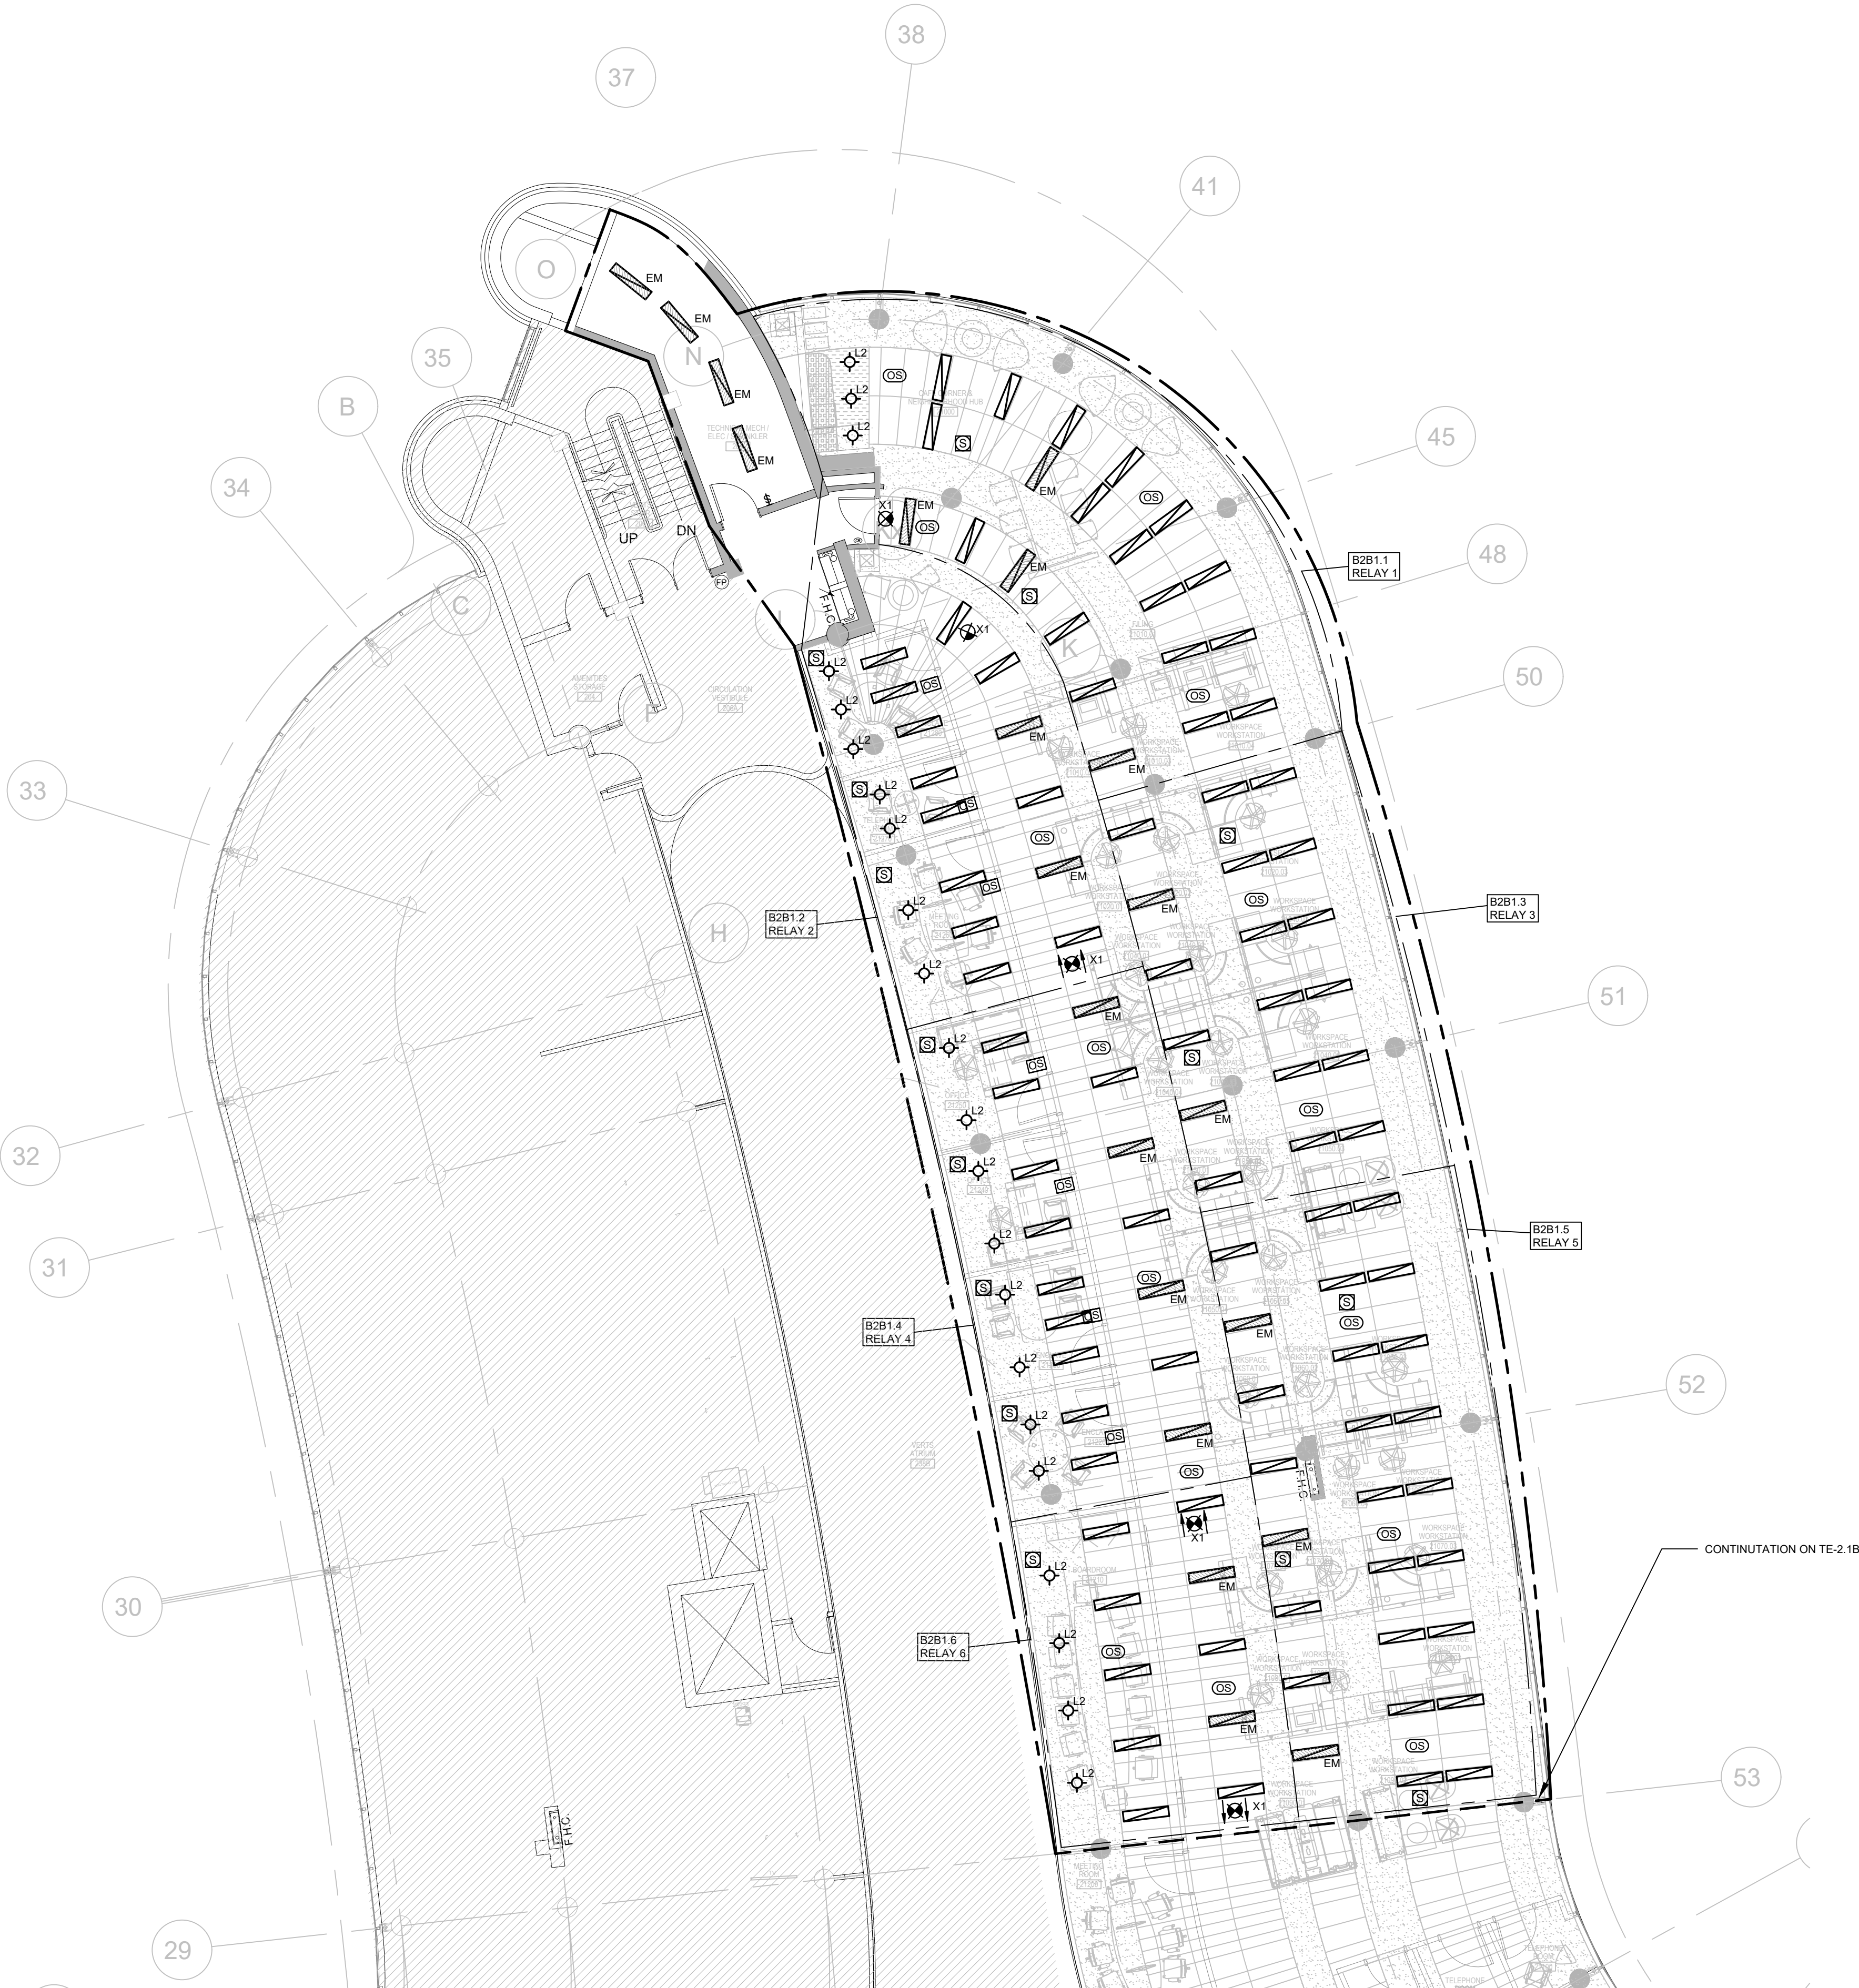

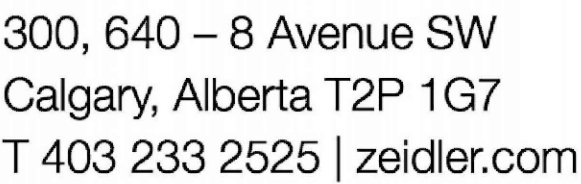

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PROJECT
YORK REGION
MUNICIPALITY CENTRE


PROJECT ADDRESS
17250 YONGE STREET, NEWMARKET, ONTARIO L3Y 4W5


PARTIAL SECOND FLOOR POWER & SYSTEMS LAYOUT

PROJECT NO.	DRAWN	CHECKED
14008-025-E	JB	WYC/NC

DRAWING NO. **11-00A** SCALE **1:100**

TE-2.2A

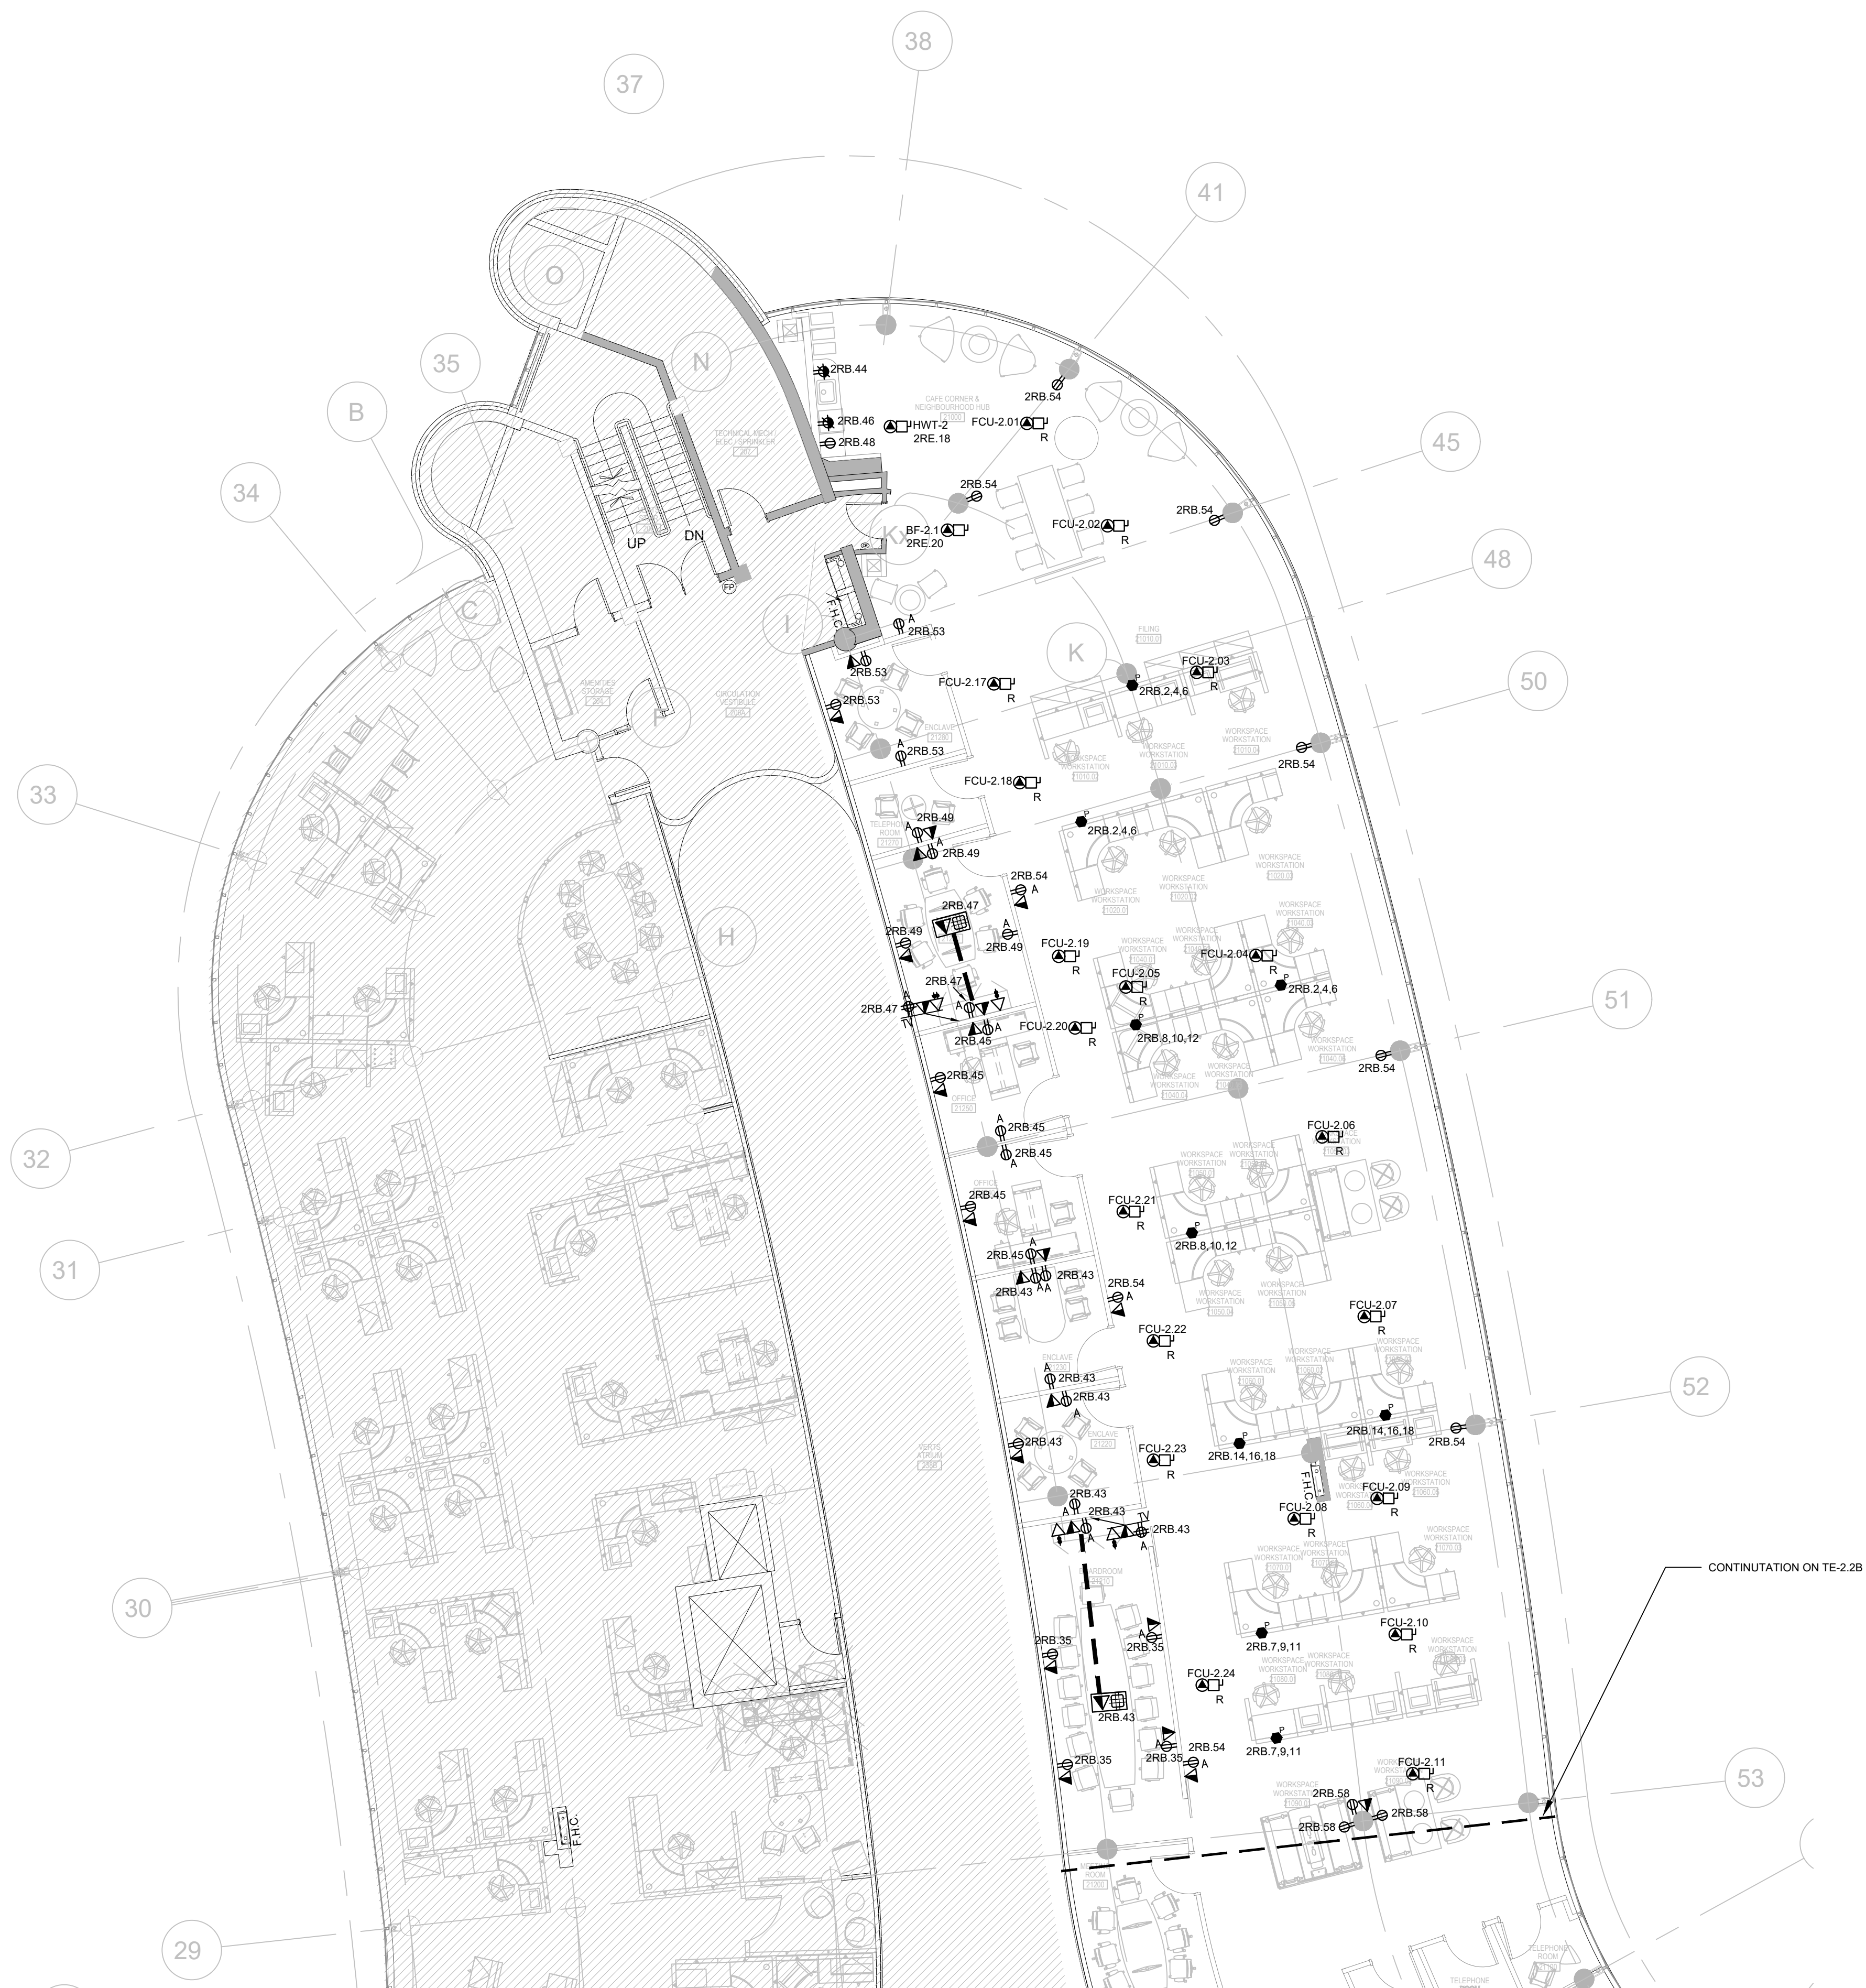

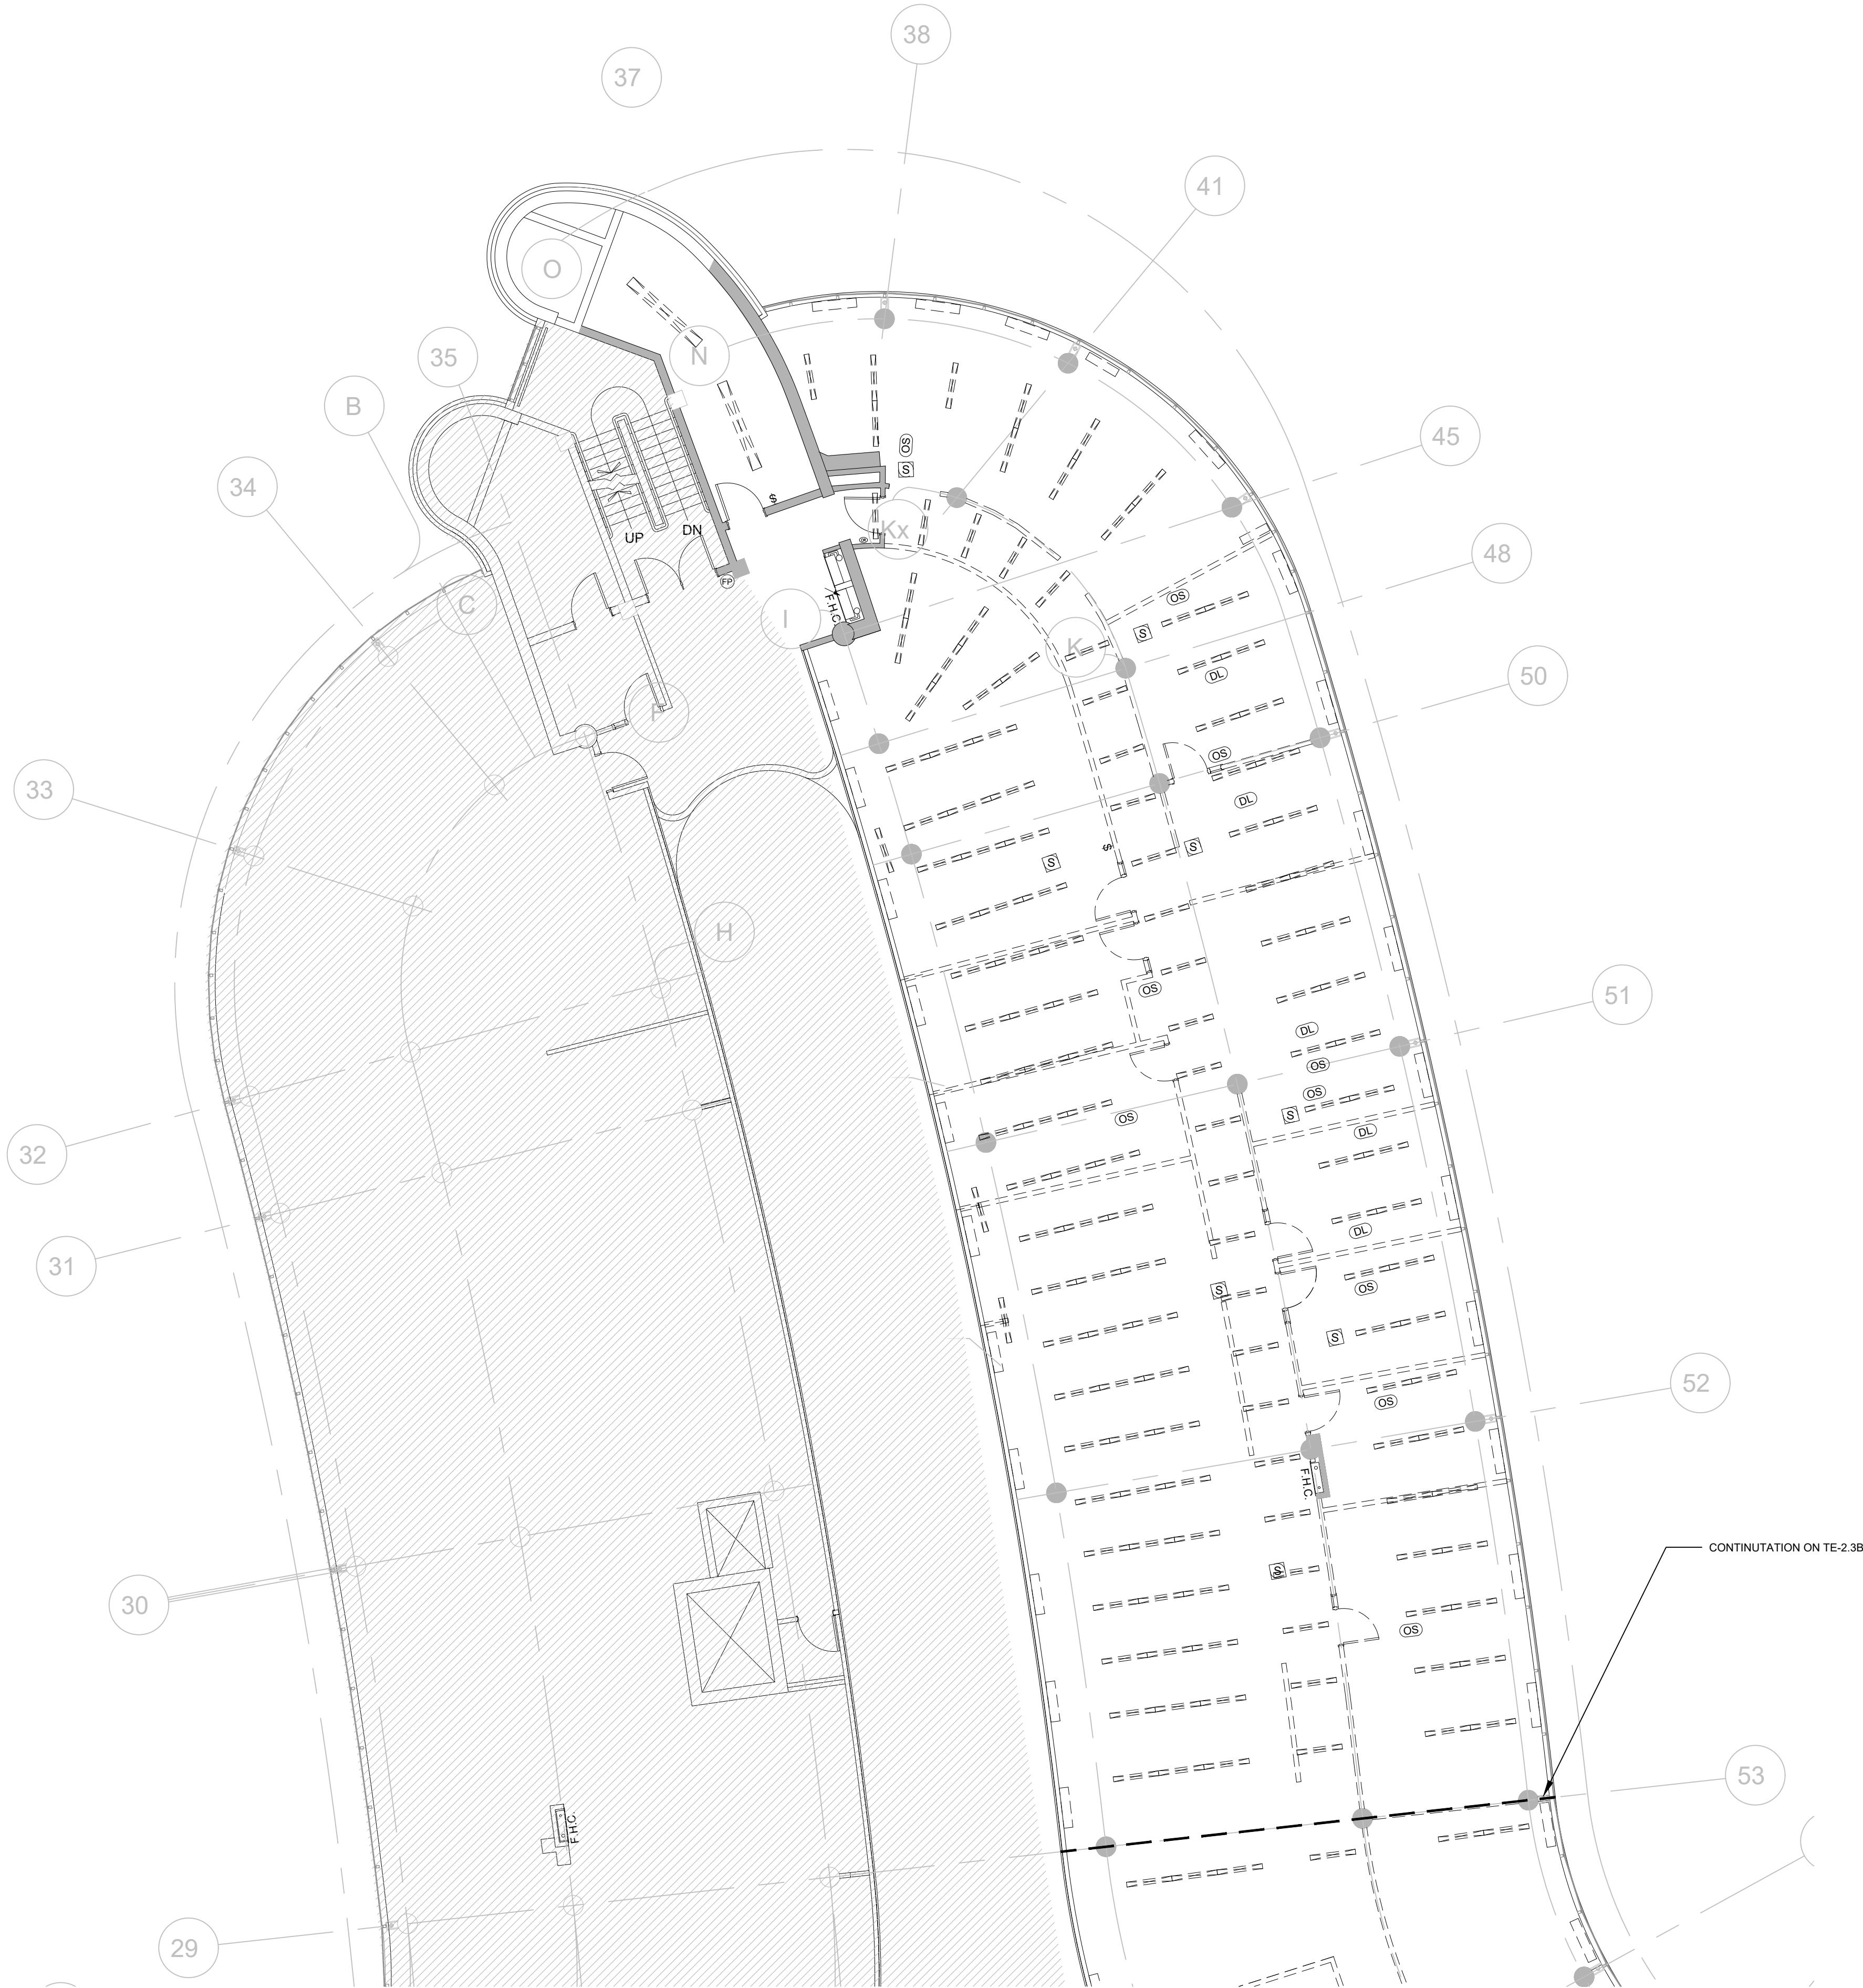

- GENERAL NOTES:
1. REFER TO THE ARCHITECT'S DRAWINGS TO DETERMINE COMPLETE EXTENT OF DEMOLITION AND ALLOW FOR ALL COSTS. COMPLETE EXTENT OF DEMOLITION IS NOT SHOWN.
 2. ENSURE THAT ALL EXISTING ELECTRICAL DEVICES, EQUIPMENT AND LIGHTING WITHIN BASE BUILDING ROOMS, STAIRWELLS AND AREAS DEEMED NOT IN SCOPE, REMAIN LIVE OPERATIONAL, ISOLATED AND PROTECTED DURING CONSTRUCTION.
 3. COORDINATE ALL WORK TO SUIT PROJECT PHASE SCHEDULE. COORDINATE PHASING WITH ARCHITECT/INTERIOR DESIGN/GC DRAWINGS. PHASING IF SHOWN IS FOR REFERENCE PURPOSES ONLY.
 4. EXISTING CONDITIONS SHOWN ARE BASED ON DRAWINGS, FIELD SURVEY AND INFORMATION PROVIDED BY LANDLORD. ELECTRICAL CONTRACTOR TO FIELD VERIFY ALL EXISTING CONDITIONS PRIOR TO BIDDING. ANY DISCREPANCIES BETWEEN EXISTING CONDITIONS AND THOSE SHOWN HERE SHALL BE BROUGHT TO THE ATTENTION OF THE PROJECT MANAGER PRIOR TO BIDDING.
 5. NO ADDITIONAL COST WILL BE APPROVED FOR ANY REVISIONS/MODIFICATIONS REQUIRED BY ANY TRADE OR CONTRACTOR DUE TO THE LACK OF COORDINATION BETWEEN TRADES AND CONTRACTORS.
 6. COORDINATE WITH GENERAL CONTRACTOR AND LANDLORD FOR DISPOSAL OF ALL MATERIALS FROM SITE.



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NOTE

PROJECT CONTACT

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EMAIL: john.bei@smithandandersen.com

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PROJECT
YORK REGION
MUNICIPALITY CENTRE


PROJECT ADDRESS
17250 YONGE STREET, NEWMARKET, ONTARIO L3Y 4W5

TITLE

PARTIAL SECOND FLOOR
LIGHTING & FIRE ALARM
DEMOLITION LAYOUT

PROJECT NO. 14008-025-E
DRAWN JB
CHECKED WYC/NC

DRAWING NO. TE-2.3A
SCALE 1:100

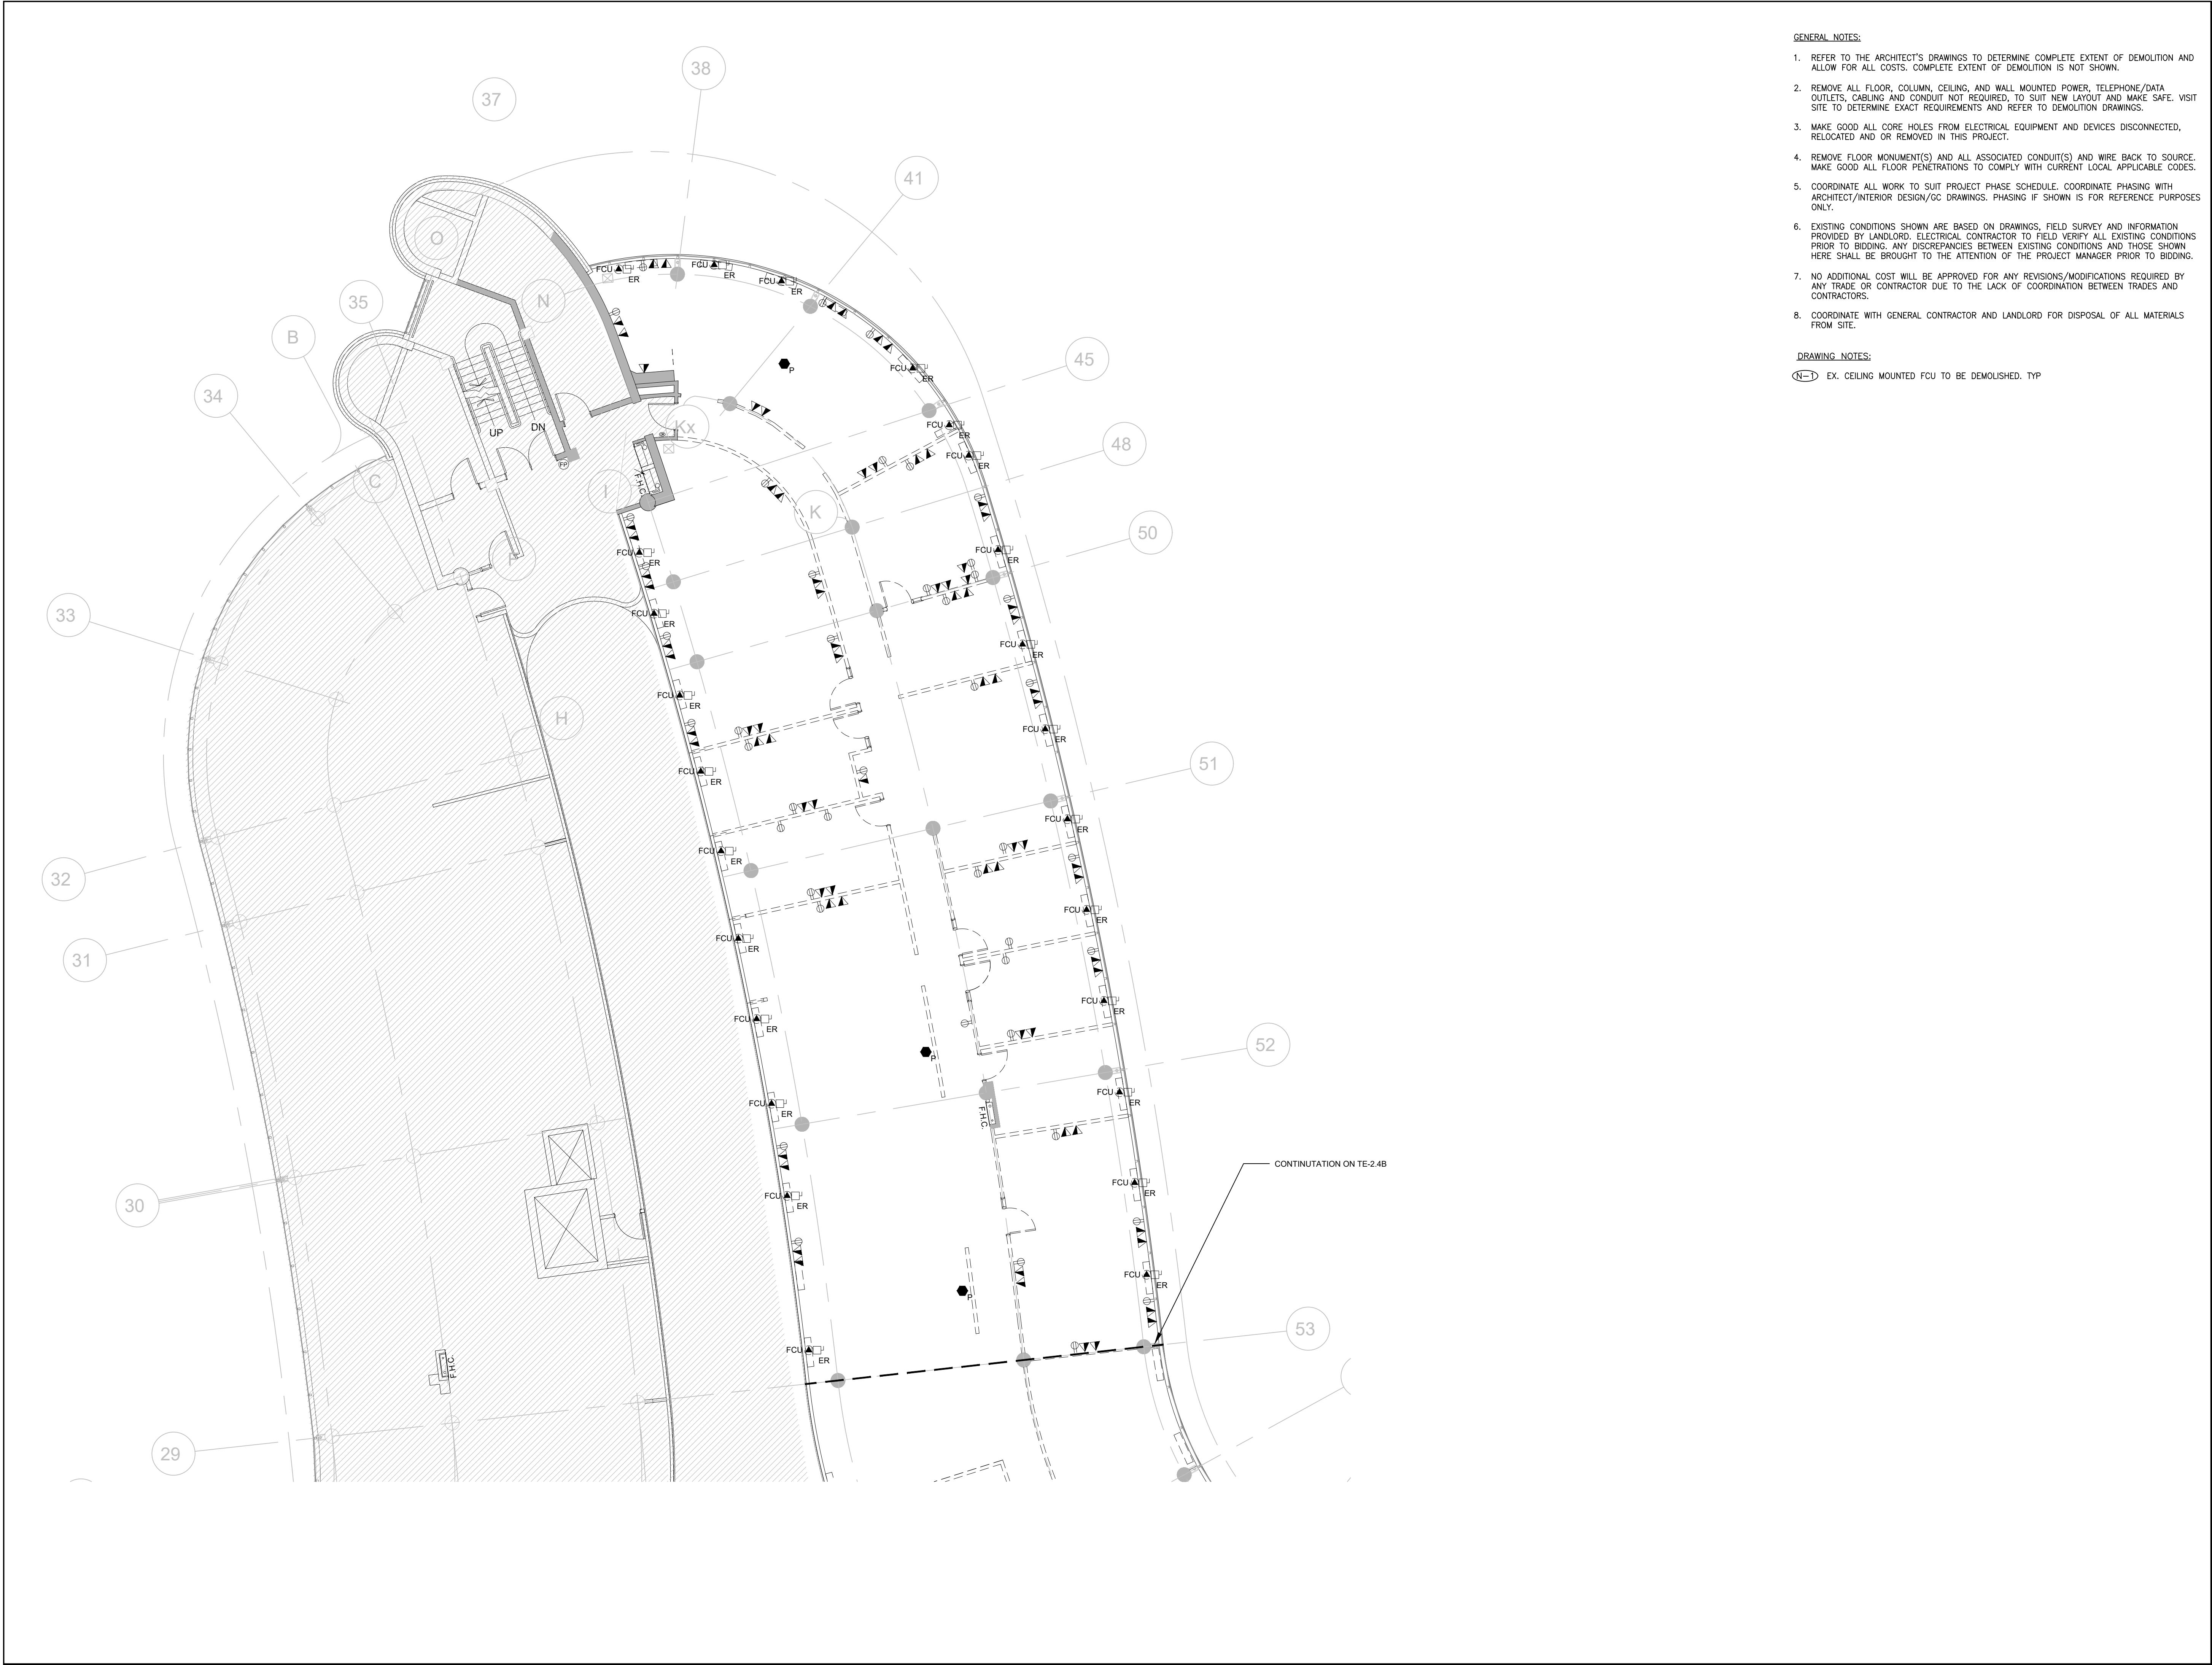

- GENERAL NOTES:**
1. REFER TO THE ARCHITECT'S DRAWINGS TO DETERMINE COMPLETE EXTENT OF DEMOLITION AND ALLOW FOR ALL COSTS. COMPLETE EXTENT OF DEMOLITION IS NOT SHOWN.
 2. REMOVE ALL FLOOR, COLUMN, CEILING, AND WALL MOUNTED POWER, TELEPHONE/DATA OUTLETS, CABLING AND CONDUIT NOT REQUIRED, TO SUIT NEW LAYOUT AND MAKE SAFE. VISIT SITE TO DETERMINE EXACT REQUIREMENTS AND REFER TO DEMOLITION DRAWINGS.
 3. MAKE GOOD ALL CORE HOLES FROM ELECTRICAL EQUIPMENT AND DEVICES DISCONNECTED, RELOCATED AND OR REMOVED IN THIS PROJECT.
 4. REMOVE FLOOR MONUMENT(S) AND ALL ASSOCIATED CONDUIT(S) AND WIRE BACK TO SOURCE. MAKE GOOD ALL FLOOR PENETRATIONS TO COMPLY WITH CURRENT LOCAL APPLICABLE CODES.
 5. COORDINATE ALL WORK TO SUIT PROJECT PHASE SCHEDULE. COORDINATE PHASING WITH ARCHITECT/INTERIOR DESIGN/GC DRAWINGS. PHASING IF SHOWN IS FOR REFERENCE PURPOSES ONLY.
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 8. COORDINATE WITH GENERAL CONTRACTOR AND LANDLORD FOR DISPOSAL OF ALL MATERIALS FROM SITE.

DRAWING NOTES:

(N-D) EX. CEILING MOUNTED FCU TO BE DEMOLISHED. TYP



Zeidler Architecture

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NOTE

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PROJECT
YORK REGION
MUNICIPALITY CENTRE

PROJECT ADDRESS
17250 YONGE STREET, NEWMARKET, ONTARIO L3Y 4W5

TITLE

PARTIAL SECOND FLOOR
POWER & SYSTEMS
DEMOLITION LAYOUT

PROJECT NO.	DRAWN	CHECKED
14008-025-E	JB	WYC/NC

DRAWING NO.	SCALE
TE-2.4A	1:100

NOTE

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PROJECT

YORK REGION
MUNICIPALITY CENTRE

PROJECT ADDRESS

17250 YONGE STREET, NEWMARKET, ONTARIO L3Y 4W5

TITLE

PARTIAL SECOND FLOOR LIGHTING & FIRE ALARM LAYOUT

PROJECT NO.	DRAWN	CHECKED
14008-025-E	JB	WYC/NC

DRAWING NO.	SCALE
T5-01B	1:100

TE-2.1B



GENERAL NOTES:

1. THESE DRAWINGS SHALL BE READ IN CONJUNCTION WITH ARCHITECT'S DRAWINGS FOR DIMENSIONS, HEIGHTS, CONSTRUCTION DETAILING, FINISHES AND COLOURS.
2. CIRCUITING IN PART IS DIAGRAMMATIC INTENDED TO SHOW GENERAL CIRCUIT ARRANGEMENT AND PANEL DESIGNATION.
3. PROVIDE EMT CONDUIT IN AREAS WITH EXPOSED CEILINGS, BX CABLEING IS NOT ACCEPTABLE UNLESS OTHERWISE NOTED, BX CABLES MAY BE USED FOR FINAL CONNECTIONS TO LIGHTING FIXTURES OR EQUIPMENT WITH A MAXIMUM HORIZONTAL DISTANCE OF 10 FEET. PROVIDE 1/2" THICK ALUMINUM PLATE TO MATCH ARCHITECTURAL BACKGROUNDS, MOUNT EXIT SIGNS, OCCUPANCY SENSORS, EXIT SIGNS, CAMERAS, WAPS AND ALL OTHER CEILING MOUNTED DEVICES WITH STEMS SUCH THAT THEY ARE ON THE SAME PLANE AS SUSPENDED LIGHTING FIXTURES, COORDINATE CEILINGS AND WALL HEIGHTS WITH INTERIOR DESIGNER DRAWINGS.
4. REFER TO LIGHTING LAYOUT SHOWN FOR FINAL LOCATION ONLY. VISIT THE SITE AND COORDINATE EXACT QUANTITY OF LIGHTING LUMINAIRES TO BE NEW, RELOCATED, AND/OR EXISTING. EXISTING LIGHTING LUMINAIRES TO BE REMOVED TO MATCH ARCHITECT WHERE INSUFFICIENT QUANTITY EXIST TO SUIT. ALL RELOCATED LUMINAIRES SHALL HAVE WIRING EXTENDED TO SUIT NEW LOCATION, OFFER ALL EXISTING EXISTING LUMINAIRES TO LANDLORD AND RETURN CANNOT ALL SELECTED LUMINAIRES AT A PRICE DESIGNATED BY LANDLORD. DISPOSE OF ALL LUMINAIRES REJECTED BY LANDLORD.
5. ALL NEW/RELOCATED BASE BUILDING STANDARD LUMINAIRES AND NEW RECESSED DOWN LIGHTS TO BE SHOWN HUNG AND ORIENTED FROM THE PLAN ABOVE. PROVIDE LETTER TO BE INCLUDED AS PART OF CLOSE-OUT DOCUMENT SUBMITTAL PACKAGE.
6. RELAP EXISTING AND RELOCATED LUMINAIRES DUE TO BURNOUT CONDITIONS AND REPLACE FAULTY BALLASTS AS REQUIRED, INCLUDE IN BASE PRICE.
7. REWORK EXISTING EMERGENCY LIGHTING TO ACHIEVE NEW EMERGENCY LIGHTING AS SHOWN. CONNECT NEW AND/OR EXISTING LUMINAIRES TO NEAREST EMERGENCY LIGHTING CIRCUIT ON THIS FLOOR, PROVIDE 347-120V LIGHTING TRANSFORMERS AS REQUIRED. IF NEW EMERGENCY BRANCH CIRCUITS ARE REQUIRED FOR EMERGENCY LIGHTING AND EXISTING EMERGENCY LIGHTING PANEL IS LOCATED ON A DIFFERENT STOREY (i.e. NOT LOCATED ON SAME STOREY) THEN NEW EMERGENCY BRANCH CIRCUIT SHALL BE INSTALLED (i.e. MI CABLE) TO FIRST EMERGENCY LIGHT FID, IF EXISTING EMERGENCY LIGHTING PANEL IS LOCATED ON THE SAME STOREY, THE NEW BRANCH CIRCUIT WIRING DOES NOT NEED TO BE FIRE RATED. PROVIDE LOCK-ON BREAKERS TO SUIT.
8. MEASURE THE ILLUMINATION OF THE FLOOR AT NIGHT WITH EMERGENCY LIGHTING ON ONLY, AND SEND A DRAWING SHOWING THE MAXIMUM AND MINIMUM LEVEL OF ILLUMINATION, TO CONSULTING ENGINEER, FOR REVIEW. PROVIDE WRITTEN INFORMATION THAT EMERGENCY LIGHTING HAS BEEN INSTALLED IN ACCORDANCE WITH CONTRACT DOCUMENTS AND LATEST EDITION OF THE ONTARIO BUILDING CODE SECTIONS 3.2.7.3 AND 3.2.7.4. LETTER TO BE INCLUDED AS PART OF CLOSE-OUT DOCUMENT SUBMITTAL PACKAGE.
9. PROVIDE NEW PICTOGRAM (RUNNING MAN) TYPE EXIT SIGNS, **FACES AND INDICATOR ARROWS AS PER DRAWINGS AND UNIVERSAL 120-347VAC VOLTAGE INPUT UNLESS OTHERWISE NOTED**. CONNECT NEW EXIT SIGNS TO THE NEAREST AVAILABLE SPARE EXIT LIGHTING CIRCUIT. PROVIDE WRITTEN INFORMATION THAT EXIT SIGNS ARE INSTALLED TO EXIT SIGNS (COMPLETE WITH MATERIAL AND LABOUR) TO BE INSTALLED AS PER EXIT LIGHTING REQUIREMENTS UPON FINAL INSPECTION PER EACH AREA.
10. LOCATE AND POSITION EXIT SIGNS SUCH THAT THEY DO NOT INTERFERE WITH ADJACENT EXIT SIGNS AND EMERGENCY LIGHTING COVERAGE.
11. ALL MODIFICATIONS TO FIRE ALARM SYSTEM AND DEVICES TO BE COMPLETED BY BASE BUILDING FIRE ALARM CONTRACTOR AND VENDOR/MANUFACTURER. BASE BUILDING FIRE ALARM CONTRACTOR/VENDOR/MANUFACTURER IS RESPONSIBLE TO ENSURE THAT ALL ADDITIONAL COMPONENTS (MATERIAL, SUPPLY, INCLUDING ANY LABOUR TO INSTALL OR MODIFY FIRE ALARM DEVICES) ARE INCLUDED FOR BASED ON ISSUED DRAWINGS. PROVIDE WRITTEN INFORMATION THAT ALL ADDITIONAL COMPONENTS (MATERIAL, SUPPLY, INCLUDING ANY LABOUR) TO BE INSTALLED AS PER FIRE ALARM **SPEAKER** ARE TO MATCH EXISTING AND BE CONNECTED TO NEAREST AVAILABLE SPARE EMERGENCY ZONE CIRCuits. CONNECT NEW **SPEAKER** TO EXISTING CIRCUITS, WHERE THERE IS SUFFICIENT CAPACITY ON RESPECTIVE CIRCUITS. IF THERE IS NO CAPACITY ON EXISTING CIRCUITS, PROVIDE NEW CIRCUITS, ALLOW FOR ALL ASSOCIATED COSTS INCLUDING BUT NOT LIMITED TO; ASSOCIATED EQUIPMENT, DEVICES, PROGRAMMING, TESTING AND VERIFICATION TO MAKE SYSTEM OPERATIONAL AND CODE COMPLIANT. ALL FIRE ALARM SYSTEMS SHALL BE INSTALLED IN CONFORMANCE WITH CAN/ULC-5524 LATEST EDITION.
12. ENSURE THAT ALL LIGHTING FIXTURES ARE CLEAN AND ILLUMINATED BY END OF PROJECT.
13. ENSURE EXISTING FIXTURES OUTSIDE OF THE SCOPE OF WORK FED FROM EXISTING CIRCUITS THAT ARE DISCONNECTED AS PART OF THE DEMOLITION SCOPE ARE RECONNECTED TO EXISTING LIGHTING CIRCUITS. CONTRACTOR TO PROVIDE ADDITIONAL CIRCUITS WHERE REQUIRED TO PROVIDE LOW VOLTAGE CIRCUITS TO EXISTING LIGHTING FIXTURES WITH LANDLORD AND REARRANGED TO SUIT NEW LAYOUT. ALL LIGHTING, INCLUDING EXISTING, WITHIN THE TENANT PREMISES TO BE ON A SEPARATE LIGHTING ZONE AND TO BE SEPARATED FROM LOW VOLTAGE CIRCUITS. CONTRACTOR SYSTEM PROVIDE ALL NECESSARY RELAYS, CONTACTORS, RELAY PANELS, AND DRY INTERFACES REQUIRED FOR SUCH CONTROL. INCLUDE COST IN THIS CONTRACT.
14. LIGHTING FIXTURES IDENTIFIED AS EMERGENCY ARE TO BE CONNECTED SO THAT UNDER NORMAL CONDITIONS THEY WORK IN CONJUNCTION WITH THE SWITCHING AS IDENTIFIED. IN THE EVENT OF AN EMERGENCY, THESE LIGHTS ARE TO BE FORCED ON WITH THE USE OF ELECTRICAL CONTACTOR TO ALLOW FOR LIGHT REPEAT VERIFICATION. ACTIVATE THE LIGHTS TO FULL BRIGHTNESS. REFER TO DETAIL **7/TE-0.6** FOR REQUIREMENTS.
15. COORDINATE INSTALLATION OF FIXTURES WITH MECHANICAL EQUIPMENT, ELECTRICAL EQUIPMENT, SPRINKLERS AND DUCT WORK WITH OTHER TRADES PRIOR TO WORK COMMENCING.
16. ALL CEILING MOUNTED OCCUPANCY SENSORS PROVIDED AS PART OF THIS SCOPE OF WORK MUST BE LOCATED AT LEAST 60" AWAY FROM ANY SUPPLY AIR DIFFUSER AND RETURN AIR GRILLE AS PER MANUFACTURER'S RECOMMENDATION. COORDINATE INSTALLATION ON SITE WITH MECHANICAL CONTRACTOR PRIOR TO COMMENCING WORK.
17. FIRE ALARM TESTING CAN ONLY BE DONE BETWEEN THE HOURS OF 7AM AND 8AM. FIRE ALARM CONTRACTOR TO PLAN FOR THIS AND SCHEDULE SITE VISITS AS REQUIRED.
18. IN ADDITION TO THE FIRE ALARM DEVICES INDICATED ON DRAWINGS, BASE BID PRICE SHALL INCLUDE FOR PROVISION (SUPPLY AND INSTALL) OF AN ADDITIONAL THIRD (3) FIRE ALARM SPEAKER/STROBE FOR THIS FLOOR COMPLETE WITH 30'-0" CONDUIT AND WIRING (PER DEVICE), PROGRAMMING, TESTING AND VERIFICATION BY BASE BUILDING FIRE ALARM REPEAT VERIFICATION FOR EACH DEVICE POST CITY FIRE DEPARTMENT INSPECTION.
19. ONCE THE THERMOSTAT OVERRIDE BUTTON IS VERIFIED, THE LIGHTING SYSTEM IS TO ACTIVATE THE HALLWAY LIGHTING. COORDINATE LOCATION OF THERMOSTAT WITH MECHANICAL.

DRAWING NOTES:

- (N-1) ALL FIXTURES ARE TYPE "L1" UNLESS OTHERWISE NOTED. TYPE
(N-2) FINAL LOCATION OF POTLIGHTS TO BE COORDINATED ON-SITE. TYPE



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NOTE

PROJECT CONTACT

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THIS DRAWING SHALL BE READ IN CONJUNCTION WITH ELECTRICAL SPECIFICATION SUBMITTED FOR THIS PROJECT.

3.	ISSUED FOR TENDER	2026.02.24
5.	ISSUED FOR TENDER	2026.01.30
4.	ISSUED FOR PERMIT	2026.01.16
3.	ISSUED FOR 100% REVIEW	2025.11.14
2.	ISSUED FOR 90% REVIEW	2025.10.03
1.	ISSUED FOR 60% REVIEW	2025.06.27
NO.	ISSUED/REVISION	DATE



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PROJECT
YORK REGION
MUNICIPALITY CENTRE

PROJECT ADDRESS
17250 YONGE STREET, NEWMARKET, ONTARIO L3Y 4W5

TITLE

PARTIAL SECOND FLOOR POWER & SYSTEMS LAYOUT

PROJECT NO.	DRAWN	CHECKED
14008-025-E	JB	WYC/NO

DRAWING NO. **T5 005** SCALE **1:100**

TE-2.2B



GENERAL NOTES:

3. THESE DRAWINGS SHALL BE READ IN CONJUNCTION WITH ARCHITECT'S DRAWINGS FOR DIMENSIONS, HEIGHTS, CONSTRUCTION DETAILING, FINISHES AND COLOURS.
4. CIRCUITING IN PART IS DIAGRAMMATIC INTENDED TO SHOW GENERAL CIRCUIT ARRANGEMENT AND PANEL DESIGNATION.
5. PROVIDE EMT CONDUIT IN AREAS WITH EXPOSED CEILINGS, BX CABLEING IS NOT ACCEPTABLE UNLESS OTHERWISE NOTED. BX CABLES MAY BE USED FOR FINAL CONNECTIONS TO LIGHTING FIXTURES OR EQUIPMENT WITH A MAXIMUM HORIZONTAL RUN ON THE SAME PLANE OF 1' METER. PAINT CONDUITS TO MATCH ARCHITECTURAL BACKGROUNDS. MOUNT EXIT SIGNS, OCCUPANCY SENSORS, EXIT SIGNS, CAMERAS, WAPS AND ALL OTHER CEILING MOUNTED DEVICES WITH STEMS SUCH THAT THEY ARE IN THE SAME PLANE AS SUSPENDED LIGHTING FIXTURES. COORDINATE CEILINGS AND WALL HEIGHTS WITH INTERIOR DESIGNER DRAWINGS.
6. REUSE CIRCUITS OBTAINED THROUGH DEMOLITION IS ACCEPTABLE.
7. VERIFY EXACT POWER REQUIREMENTS AND RECEPTACLE TYPES FOR SPECIAL EQUIPMENT WITH MANUFACTURER PRIOR TO INSTALLATION. PROVIDE HARDWARE CONNECTIONS FOR DISHWASHERS AND COPIERS ETC. IN LIEU OF RECEPTACLES OR VICE VERSA, AS REQUIRED.
8. REFER TO ARCHITECT DRAWINGS FOR THE COLOUR OF COVERPLATES AND MOUNTING HEIGHTS.
9. MARK UP OUTLET AND DEVICE LOCATIONS AND OBTAIN APPROVAL BY DESIGN CONSULTANT PRIOR TO INSTALLATION.
10. PROVIDE SUITABLE LABELS ON ALL RECEPTACLES AND SYSTEM FURNITURE FEEDS. LABELS TO INCLUDE BOTH PANEL AND CIRCUIT DESIGNATION. REVIEW LABEL SIZE AND TYPE WITH CONSULTANT PRIOR TO INSTALLATION.
11. TRACE ALL EXISTING OUTLETS, NOTED AS EXISTING, AND IDENTIFY ON AS BUILT DRAWING AS PER SPECIFICATION.
12. ALLOW FOR THE REMOVAL AND RE-INSTALLATION OF SYSTEMS FURNITURE CONNECTIONS.
13. CONFIRM ELECTRICAL REQUIREMENTS AND EXACT LOCATION OF ALL MECHANICAL EQUIPMENT WITH MECHANICAL DRAWINGS AND CONTRACTOR PRIOR TO ROUGH-INS.
14. ROUTE ALL CONDUIT SYSTEMS AROUND DUCT WORK, BEAMS AND PIPING AS REQUIRED TO ACCOMMODATE LAYOUT SHOWN. REFER TO MECHANICAL DRAWINGS AND ARCHITECTURAL DRAWINGS FOR ADDITIONAL DETAILS.

DRAWING NOTES:

- N-2 RELOCATED CEILING MOUNTED FCU POWER CONNECTIONS SHOWN. ENSURE CIRCUITS ARE NOT OVERLOADED. REFER TO MECHANICAL DRAWINGS FOR FURTHER INFORMATION. TYP.

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PROJECT
YORK REGION
MUNICIPALITY CENTRE

PROJECT ADDRESS
17250 YONGE STREET, NEWMARKET, ONTARIO L3Y 4W5

TITLE

PARTIAL SECOND FLOOR
LIGHTING & FIRE ALARM
DEMOLITION LAYOUT

PROJECT NO.	DRAWN	CHECKED
14008-025-E	JB	WYC/NC

DRAWING NO.	SCALE
TE-2.3B	1:100



- GENERAL NOTES:
1. REFER TO THE ARCHITECT'S DRAWINGS TO DETERMINE COMPLETE EXTENT OF DEMOLITION AND ALLOW FOR ALL COSTS. COMPLETE EXTENT OF DEMOLITION IS NOT SHOWN.
 2. ENSURE THAT ALL EXISTING ELECTRICAL DEVICES, EQUIPMENT AND LIGHTING WITHIN BASE BUILDING ROOMS, STAIRWELLS AND AREAS DEEMED NOT IN SCOPE, REMAIN LIVE OPERATIONAL, ISOLATED AND PROTECTED DURING CONSTRUCTION.
 3. COORDINATE ALL WORK TO SUIT PROJECT PHASE SCHEDULE. COORDINATE PHASING WITH ARCHITECT/INTERIOR DESIGN/GC DRAWINGS. PHASING IF SHOWN IS FOR REFERENCE PURPOSES ONLY.
 4. EXISTING CONDITIONS SHOWN ARE BASED ON DRAWINGS, FIELD SURVEY AND INFORMATION PROVIDED BY LANDLORD. ELECTRICAL CONTRACTOR TO FIELD VERIFY ALL EXISTING CONDITIONS PRIOR TO BIDDING. ANY DISCREPANCIES BETWEEN EXISTING CONDITIONS AND THOSE SHOWN HERE SHALL BE BROUGHT TO THE ATTENTION OF THE PROJECT MANAGER PRIOR TO BIDDING.
 5. NO ADDITIONAL COST WILL BE APPROVED FOR ANY REVISIONS/MODIFICATIONS REQUIRED BY ANY TRADE OR CONTRACTOR DUE TO THE LACK OF COORDINATION BETWEEN TRADES AND CONTRACTORS.
 6. COORDINATE WITH GENERAL CONTRACTOR AND LANDLORD FOR DISPOSAL OF ALL MATERIALS FROM SITE.



- GENERAL NOTES:**
1. REFER TO THE ARCHITECT'S DRAWINGS TO DETERMINE COMPLETE EXTENT OF DEMOLITION AND ALLOW FOR ALL COSTS. COMPLETE EXTENT OF DEMOLITION IS NOT SHOWN.
 2. REMOVE ALL FLOOR, COLUMN, CEILING, AND WALL MOUNTED POWER, TELEPHONE/DATA OUTLETS, CABLING AND CONDUIT NOT REQUIRED, TO SUIT NEW LAYOUT AND MAKE SAFE. VISIT SITE TO DETERMINE EXACT REQUIREMENTS AND REFER TO DEMOLITION DRAWINGS.
 3. MAKE GOOD ALL CORE HOLES FROM ELECTRICAL EQUIPMENT AND DEVICES DISCONNECTED, RELOCATED AND OR REMOVED IN THIS PROJECT.
 4. REMOVE FLOOR MONUMENT(S) AND ALL ASSOCIATED CONDUIT(S) AND WIRE BACK TO SOURCE. MAKE GOOD ALL FLOOR PENETRATIONS TO COMPLY WITH CURRENT LOCAL APPLICABLE CODES.
 5. COORDINATE ALL WORK TO SUIT PROJECT PHASE SCHEDULE. COORDINATE PHASING WITH ARCHITECT/INTERIOR DESIGN/GC DRAWINGS. PHASING IF SHOWN IS FOR REFERENCE PURPOSES ONLY.
 6. EXISTING CONDITIONS SHOWN ARE BASED ON DRAWINGS, FIELD SURVEY AND INFORMATION PROVIDED BY LANDLORD. ELECTRICAL CONTRACTOR TO FIELD VERIFY ALL EXISTING CONDITIONS PRIOR TO BIDDING. ANY DISCREPANCIES BETWEEN EXISTING CONDITIONS AND THOSE SHOWN HERE SHALL BE BROUGHT TO THE ATTENTION OF THE PROJECT MANAGER PRIOR TO BIDDING.
 7. NO ADDITIONAL COST WILL BE APPROVED FOR ANY REVISIONS/MODIFICATIONS REQUIRED BY ANY TRADE OR CONTRACTOR DUE TO THE LACK OF COORDINATION BETWEEN TRADES AND CONTRACTORS.
 8. COORDINATE WITH GENERAL CONTRACTOR AND LANDLORD FOR DISPOSAL OF ALL MATERIALS FROM SITE.

DRAWING NOTES:

(N-1) EX. CEILING MOUNTED FCU TO BE DEMOLISHED. TYP



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NOTE

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1.	ISSUED FOR 60% REVIEW	2025.06.27
NO.	ISSUED/REVISION	DATE



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PROJECT
YORK REGION
MUNICIPALITY CENTRE

PROJECT ADDRESS
17250 YONGE STREET, NEWMARKET, ONTARIO L3Y 4W5

TITLE

PARTIAL SECOND FLOOR
POWER & SYSTEMS
DEMOLITION LAYOUT

PROJECT NO.	DRAWN	CHECKED
14008-025-E	JB	WYC/NC

DRAWING NO.	SCALE
TE-2.4B	1:100



NOTE

PROJECT CONTACT

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NO.	ISSUED/REVISION	DATE



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PROJECT

YORK REGION
MUNICIPALITY CENTRE

PROJECT ADDRESS

17250 YONGE STREET, NEWMARKET, ONTARIO L3Y 4W5

TITLE

PARTIAL SECOND FLOOR LIGHTING & FIRE ALARM LAYOUT

PROJECT NO.	DRAWN	CHECKED
14008-025-E	JB	WYC/NC

DRAWING NO. **T5-010** SCALE **1:100**

TE-2.1C



GENERAL NOTES:

1. THESE DRAWINGS SHALL BE READ IN CONJUNCTION WITH ARCHITECT'S DRAWINGS FOR DIMENSIONS, HEIGHTS, CONSTRUCTION DETAILING, FINISHES AND COLOURS.
2. CIRCUITING IN PART IS DIAGRAMMATIC INTENDED TO SHOW GENERAL CIRCUIT ARRANGEMENT AND PANEL DESIGNATION.
3. PROVIDE EMT CONDUIT IN AREAS WITH EXPOSED CEILING, BX CABLEING IS NOT ACCEPTABLE UNLESS OTHERWISE NOTED. BX CABLES MAY BE USED FOR FINAL CONNECTIONS TO LIGHTING FIXTURES OR EQUIPMENT WITH A MAXIMUM HORIZONTAL RUN OF 10 FEET. PROVIDE SUFFICIENT CONDUIT TO MATCH ARCHITECTURAL BACKGROUNDS. MOUNT EMT SIGNS, OCCUPANCY SENSORS, EIT SIGNS, CAMERAS, WAPS AND ALL OTHER CEILING MOUNTED DEVICES WITH STEMS SUCH THAT THEY ARE ON THE SAME PLANE AS SUSPENDED LIGHTING FIXTURES. COORDINATE CEILING AND WALL HEIGHTS WITH INTERIOR DESIGNER DRAWINGS.
4. REFER TO LIGHTING LAYOUT SHOWN FOR FINAL LOCATION ONLY. VISIT THE SITE AND COORDINATE EXACT QUANTITY OF LIGHTING LUMINAIRES TO BE NEW, RELOCATED AND/OR EXISTING. PROVIDE EXISTING LOCATION OF LUMINAIRES TO MATCH ARCHITECTURAL WHERE INSUFFICIENT QUANTITY EXIST TO SUIT. ALL RELOCATED LUMINAIRES SHALL HAVE WIRING EXTENDED TO SUIT NEW LOCATION, OFFER ALL UNUSED EXISTING LUMINAIRES TO LANDLORD AND RETURN OF ALL SELECTED LUMINAIRES TO LANDLORD DESIGNATED BY LANDLORD. DISPOSE OF ALL LUMINAIRES REJECTED BY LANDLORD.
5. ALL NEW/RELOCATED BASE MOUNTING STANDARD LUMINAIRES AND NEW RECESSED DOWN LIGHTS SHALL BE CHAIN HUNG AND SUPPORTED FROM THE SAG ABOVE. PROVIDE LETTER TO BE INCLUDED AS PART OF CLOSE-OUT DOCUMENT SUBMITTAL PACKAGE.
6. RELAMP EXISTING AND RELOCATED LUMINAIRES DUE TO BURNOUT CONDITIONS AND REPLACE FAULTY BALLASTS AS REQUIRED. INCLUDE IN BASE PRICE.
7. REWORK EXISTING EMERGENCY LIGHTING TO ACHIEVE NEW EMERGENCY LIGHTING AS SHOWN. RE-TEST, TUNE AND REPROGRAM LUMINAIRES TO NEAREST EMERGENCY LIGHTING CIRCUIT ON THIS FLOOR. PROVIDE 347-120V LIGHTING TRANSFORMERS AS REQUIRED. IF NEW EMERGENCY BRANCH CIRCUITS ARE REQUIRED FOR EMERGENCY LIGHTING AND EXISTING EMERGENCY LIGHTING PANEL IS LOCATED ON A DIFFERENT STOREY (i.e. NOT LOCATED ON SAME STOREY AS WHEN EXISTING EMERGENCY LIGHTING WAS INSTALLED), PROVIDE 347-120V TO FIRST EMERGENCY LIGHT FED. IF EXISTING EMERGENCY LIGHTING PANEL IS LOCATED ON THE SAME STOREY, THE NEW BRANCH CIRCUIT WIRING DOES NOT NEED TO BE FIRE RATED. PROVIDE LOCK-ON BREAKERS TO SUIT.
8. MEASURE THE ILLUMINATION OF THE FLOOR AT NIGHT WITH EMERGENCY LIGHTING ON ONLY, AND SEND A DRAWING SHOWING THE MAXIMUM AND MINIMUM LEVEL OF ILLUMINATION, TO THE ARCHITECT/ENGINEER FOR REVIEW. PROVIDE WRITTEN CONFIRMATION THAT THE EMERGENCY LIGHTING HAS BEEN INSTALLED IN ACCORDANCE WITH CONTRACT DOCUMENTS AND LATEST EDITION OF THE ONTARIO BUILDING CODE SECTIONS 3.2.7.3 AND 3.2.7.4. LETTER TO BE INCLUDED AS PART OF CLOSE-OUT DOCUMENT SUBMITTAL PACKAGE.
9. PROVIDE NEW PICTOGRAM (RUNNING MAN) TYPE EXIT SIGNS, FACES AND INDICATOR ARROWS AS PER DRAWINGS AND UNIVERSAL 120-347VAC VOLTAGE INPUT UNLESS OTHERWISE NOTED. CONNECT NEW EXIT SIGNS TO THE NEAREST AVAILABLE SPARE EXIT LIGHTING CIRCUIT OVERHEAD TO THE CIRCUIT OF THE EXISTING EXIT SIGNS. PROVIDE EXIT SIGNS (COMPLETE WITH MATERIAL AND LABOUR) TO BE INSTALLED AS PER BUILDING INSPECTOR REQUIREMENTS UPON FINAL INSPECTION PER EACH AREA.
10. LOCATE AND POSITION EXIT SIGNS SUCH THAT THEY DO NOT INTERFERE WITH ADJACENT EXIT SIGNS AND EMERGENCY LIGHTING COVERAGE.
11. ALL MODIFICATIONS TO FIRE ALARM SYSTEM AND DEVICES TO BE COMPLETED BY BASE BUILDING FIRE ALARM CONTRACTOR AND VENDOR/MANUFACTURER. BASE BUILDING FIRE ALARM CONTRACTOR/VENDOR/MANUFACTURER IS RESPONSIBLE TO ENSURE THAT ALL ADDITIONAL COMPONENTS (MATERIAL, SUPPLIES, INCLUDING ANY LABOUR TO INSTALL OR MODIFY FIRE ALARM DEVICES) ARE INCLUDED FOR BASED ON ISSUED DRAWINGS. PROVIDE CONTRACTOR TO ALLOW FOR ALL CIRCUITS, ALLOW FOR ALL ASSOCIATED COSTS INCLUDING BUT NOT LIMITED TO; ASSOCIATED EQUIPMENT, DEVICES, PROGRAMMING, TESTING AND VERIFICATION TO MAKE SYSTEM OPERATIONAL AND CODE COMPLIANT. ALL FIRE ALARM ELECTRICAL CONTRACTOR SHALL CONFIRM THAT THE LATEST EDITION OF THE FIRE ALARM SYSTEM SHALL BE INSTALLED IN CONFORMANCE WITH CAN/ULC-5524 LATEST EDITION.
12. ENSURE THAT ALL LIGHTING FIXTURES ARE CLEAN AND ILLUMINATED BY END OF PROJECT.
13. ENSURE EXISTING FIXTURES OUTSIDE OF THE SCOPE OF WORK FED FROM EXISTING CIRCUITS THAT ARE DISCONNECTED AS PART OF THE DEMOLITION SCOPE ARE RECONNECTED TO EXISTING LIGHTING CIRCUITS. CONTRACTOR TO PROVIDE ADDITIONAL CIRCUITS WHERE REQUIRED TO FEED LOW VOLTAGE LIGHTING FIXTURES TO BE RELOCATED OR REINSTALLED WITH LANDLORD AND REARRANGED TO SUIT NEW LAYOUT. ALL LIGHTING, INCLUDING EMERGENCY, WITHIN THE TENANT PREMISES TO BE ON A SEPARATE LIGHTING ZONE AND TO BE SEPARATE FROM THE LOW VOLTAGE LIGHTING ZONE. PROVIDE ALL NECESSARY RELAYS, CONTACTORS, RELAY PANELS, AND DRY INTERFACES REQUIRED FOR SUCH CONTACT. INCLUDE COST IN THIS CONTRACT.
14. LIGHTING FIXTURES IDENTIFIED AS EMERGENCY ARE TO BE CONNECTED SO THAT UNDER NORMAL CONDITIONS THEY WORK IN CONJUNCTION WITH THE SWITCHING AS IDENTIFIED. IN THE EVENT OF AN EMERGENCY, THESE LIGHTS ARE TO BE FORCED ON WITH THE USE OF ELECTRICAL AND/OR FIRE DEPARTMENT. THE FIRE DEPARTMENT SYSTEM PROVIDE ALL LIGHTS TO FULL BRIGHTNESS. REFER TO DETAIL 7/ITE-0.6 FOR REQUIREMENTS.
15. COORDINATE INSTALLATION OF FIXTURES WITH MECHANICAL EQUIPMENT, ELECTRICAL EQUIPMENT, SPRINKLERS AND DUCT WORK WITH OTHER TRADES PRIOR TO WORK COMMENCING.
16. ALL CEILING MOUNTED OCCUPANCY SENSORS PROVIDED AS PART OF THIS SCOPE OF WORK MUST BE LOCATED AT LEAST 60" AWAY FROM ANY SUPPLY AIR DIFFUSER AND RETURN AIR GRILLE AS PER MANUFACTURER'S RECOMMENDATION. COORDINATE INSTALLATION ON SITE WITH MECHANICAL CONTRACTOR PRIOR TO COMMENCING WORK.
17. FIRE ALARM TESTING CAN ONLY BE DONE BETWEEN THE HOURS OF 7AM AND 8AM. FIRE ALARM CONTRACTOR TO PLAN FOR THIS AND SCHEDULE SITE VISITS AS REQUIRED.
18. IN ADDITION TO THE FIRE ALARM DEVICES INDICATED ON DRAWINGS, BASE BID PRICE SHALL INCLUDE FOR PROVISION (SUPPLY AND INSTALL) OF AN ADDITIONAL THREE (3) FIRE ALARM SPEAKER/STROBE FOR THIS FLOOR COMPLETE WITH THREE 30"-Ø CONDUIT AND WIRING (PER DEVICE), PROGRAMMING, TESTING AND VERIFICATION BY LANDLORD. PROVIDE REPEAT VERIFICATION FOR EACH DEVICE POST CITY FIRE DEPARTMENT INSPECTION.
19. ONCE THE THERMOSTAT OVERRIDE BUTTON IS PRESSED, THE LIGHTING SYSTEM IS TO ACTIVATE THE DOWNWAY LIGHTING. COORDINATE LOCATION OF THERMOSTAT WITH MECHANICAL.

DRAWING NOTES:

- (N-1) ALL FIXTURES ARE TYPE "L1" UNLESS OTHERWISE NOTED. TYPE
(N-2) FINAL LOCATION OF POTLIGHTS TO BE COORDINATED ON-SITE. TYPE



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PROJECT
YORK REGION
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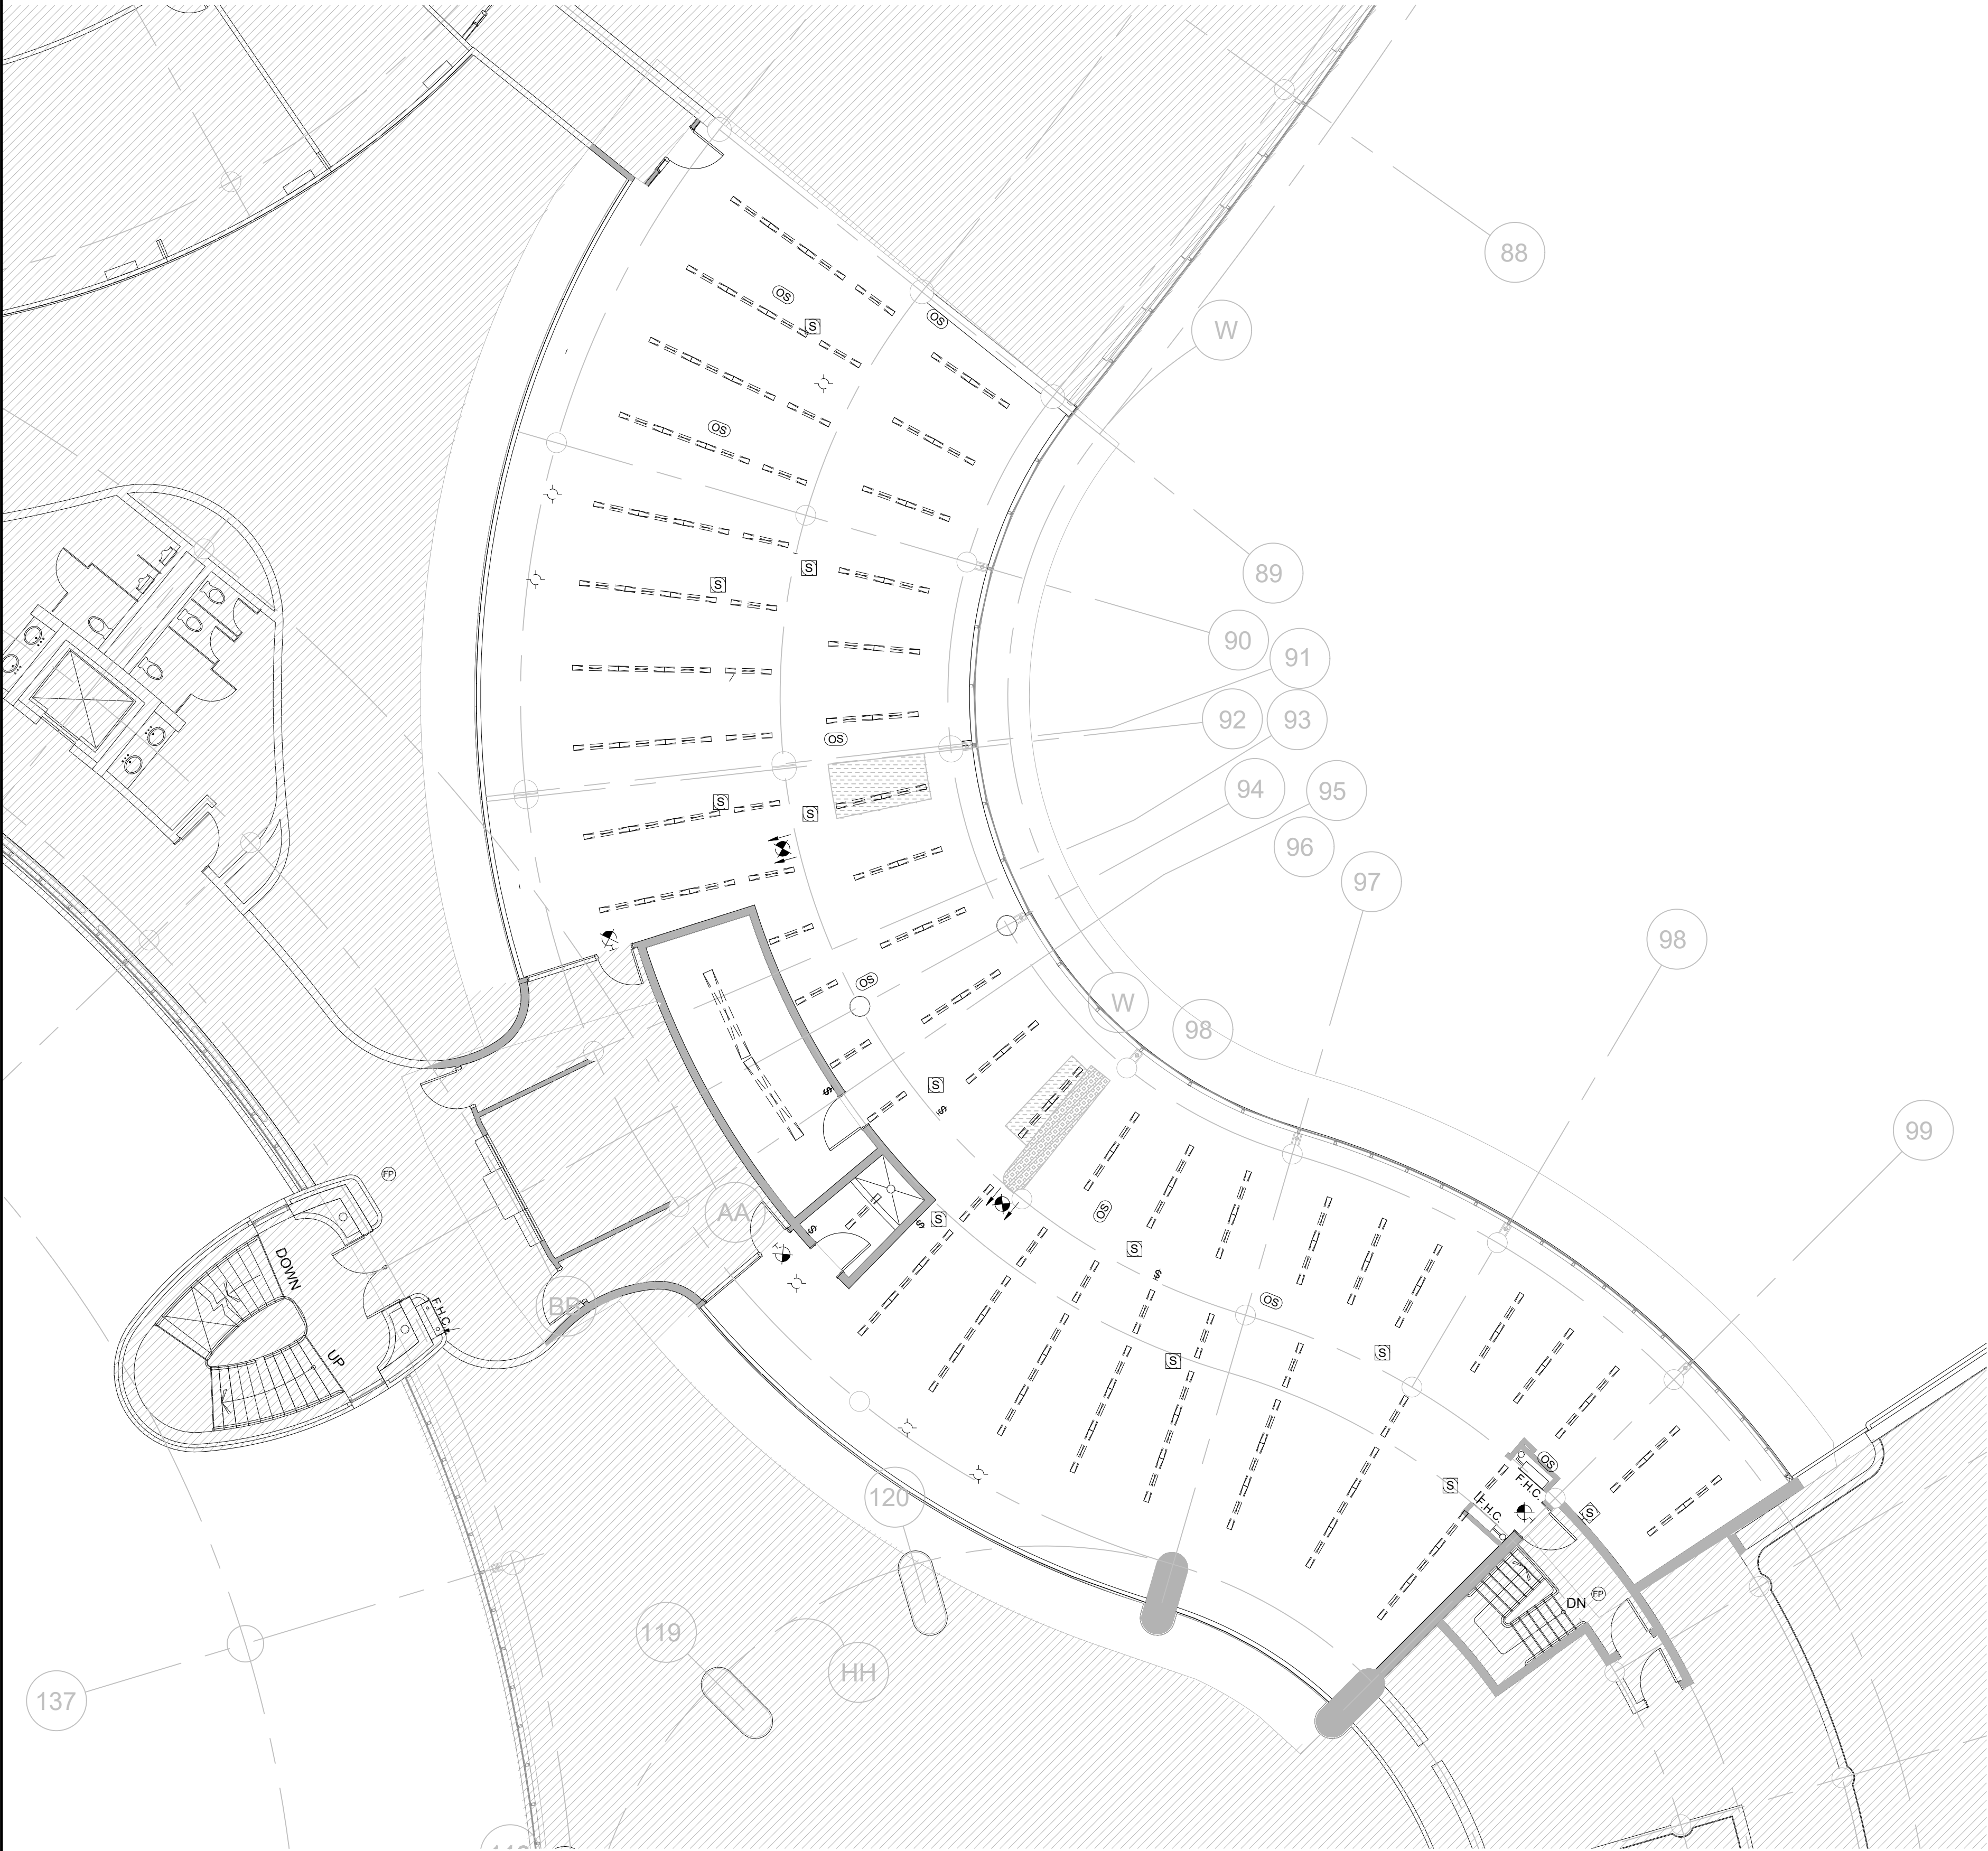
PARTIAL SECOND FLOOR POWER & SYSTEMS LAYOUT

PROJECT NO.	DRAWN	CHECKED
14008-025-E	JB	WYC/NC

DRAWING NO. **T5 000** SCALE **1:100**

TE-2.2C





- GENERAL NOTES:
1. REFER TO THE ARCHITECT'S DRAWINGS TO DETERMINE COMPLETE EXTENT OF DEMOLITION AND ALLOW FOR ALL COSTS. COMPLETE EXTENT OF DEMOLITION IS NOT SHOWN.
 2. ENSURE THAT ALL EXISTING ELECTRICAL DEVICES, EQUIPMENT AND LIGHTING WITHIN BASE BUILDING ROOMS, STAIRWELLS AND AREAS DEEMED NOT IN SCOPE, REMAIN LIVE OPERATIONAL, ISOLATED AND PROTECTED DURING CONSTRUCTION.
 3. COORDINATE ALL WORK TO SUIT PROJECT PHASE SCHEDULE. COORDINATE PHASING WITH ARCHITECT/INTERIOR DESIGN/GC DRAWINGS. PHASING IF SHOWN IS FOR REFERENCE PURPOSES ONLY.
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NOTE

PROJECT CONTACT

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TEL:	437-880-6404
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THIS DRAWING SHALL BE READ IN CONJUNCTION WITH ELECTRICAL SPECIFICATION SUBMITTED FOR THIS PROJECT.

6.	ISSUED FOR TENDER	2026.02.24
5.	ISSUED FOR TENDER	2026.01.30
4.	ISSUED FOR PERMIT	2026.01.16
3.	ISSUED FOR 100% REVIEW	2025.11.14
2.	ISSUED FOR 90% REVIEW	2025.10.03
1.	ISSUED FOR 60% REVIEW	2025.06.27
NO.	ISSUED/REVISION	DATE



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PROJECT
YORK REGION
MUNICIPALITY CENTRE

PROJECT ADDRESS
17250 YONGE STREET, NEWMARKET, ONTARIO L3Y 4W5

TITLE
PARTIAL SECOND FLOOR
LIGHTING & FIRE ALARM
DEMOLITION LAYOUT

PROJECT NO.	DRAWN	CHECKED
14008-025-E	JB	WYC/NC

DRAWING NO.	SCALE
TE-2.3C	1:100



- GENERAL NOTES:**
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 2. REMOVE ALL FLOOR, COLUMN, CEILING, AND WALL MOUNTED POWER, TELEPHONE/DATA OUTLETS, CABLING AND CONDUIT NOT REQUIRED, TO SUIT NEW LAYOUT AND MAKE SAFE. VISIT SITE TO DETERMINE EXACT REQUIREMENTS AND REFER TO DEMOLITION DRAWINGS.
 3. MAKE GOOD ALL CORE HOLES FROM ELECTRICAL EQUIPMENT AND DEVICES DISCONNECTED, RELOCATED AND OR REMOVED IN THIS PROJECT.
 4. REMOVE FLOOR MONUMENT(S) AND ALL ASSOCIATED CONDUIT(S) AND WIRE BACK TO SOURCE. MAKE GOOD ALL FLOOR PENETRATIONS TO COMPLY WITH CURRENT LOCAL APPLICABLE CODES.
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DRAWING NOTES:

(N-1) EX. CEILING MOUNTED FCU TO BE DEMOLISHED. TYP



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PROJECT
YORK REGION
MUNICIPALITY CENTRE

PROJECT ADDRESS
17250 YONGE STREET, NEWMARKET, ONTARIO L3Y 4W5

TITLE

PARTIAL SECOND FLOOR
POWER & SYSTEMS
DEMOLITION LAYOUT

PROJECT NO.	DRAWN	CHECKED
14008-025-E	JB	WYC/NC

DRAWING NO.	SCALE
TE-2.4C	1:100

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PROJECT

YORK REGION
MUNICIPALITY CENTRE

PROJECT ADDRESS

17250 YONGE STREET, NEWMARKET, ONTARIO L3Y 4W5

TITLE

PARTIAL THIRD FLOOR
LIGHTING & FIRE ALARM
LAYOUT

PROJECT NO.	DRAWN	CHECKED
14008-025-E	JB	WYC/NC


DRAWING NO.	SCALE
TE-3.1	1:100


GENERAL NOTES:

- THESE DRAWINGS SHALL BE READ IN CONJUNCTION WITH ARCHITECT'S DRAWINGS FOR DIMENSIONS, HEIGHTS, CONSTRUCTION DETAILING, FINISHES AND COLOURS.
- CIRCUITING IN PART IS DIAGRAMMATIC INTENDED TO SHOW GENERAL CIRCUIT ARRANGEMENT AND PANEL DESIGNATION.
- PROVIDE EMT CONDUIT IN AREAS WITH EXPOSED CEILINGS. BX CABLING IS NOT ACCEPTABLE UNLESS OTHERWISE NOTED. BX CABLES MAY BE USED FOR FINAL CONNECTIONS TO LIGHTING FIXTURES OR EQUIPMENT WITH A MAXIMUM HORIZONTAL RUN LENGTH OF 3 FEET / 1 METER. PAINT CONDUITS TO MATCH ARCHITECTURAL BACKGROUNDS. MOUNT EXIT SIGNS, OCCUPANCY SENSORS, EXIT SIGNS, CAMERAS, WAPS AND ALL OTHER CEILING MOUNTED DEVICES WITH STEMS SUCH THAT THEY ARE ON THE SAME PLANE AS SUSPENDED LIGHTING FIXTURES. COORDINATE CEILINGS AND WALL HEIGHTS WITH INTERIOR DESIGNER DRAWINGS.
- REFER TO LIGHTING LAYOUT SHOWN FOR FINAL LOCATION ONLY. VISIT THE SITE AND COORDINATE EXACT QUANTITY OF LIGHTING LUMINAIRES TO BE NEW, RELOCATED AND/OR RETAINED IN EXISTING LOCATION. PROVIDE NEW LUMINAIRES TO MATCH EXISTING WHERE INSUFFICIENT QUANTITY EXIST TO SUIT. ALL RELOCATED LUMINAIRES SHALL HAVE WIRING EXTENDED TO SUIT NEW LOCATION. OFFER ALL UNUSED EXISTING LUMINAIRES TO LANDLORD AND TURN OVER ALL SELECTED LUMINAIRES AT A PLACE DESIGNATED BY LANDLORD. DISPOSE OF ALL LUMINAIRES REJECTED BY LANDLORD.
- ALL NEW/RELOCATED BASE BUILDING STANDARD LUMINAIRES AND NEW RECESSED DOWN LIGHTS SHALL BE CHAIN HUNG AND SUPPORTED FROM THE SLAB ABOVE. PROVIDE LETTER TO BE INCLUDED AS PART OF CLOSE-OUT DOCUMENT SUBMITTAL PACKAGE.
- RELAMP EXISTING AND RELOCATED LUMINAIRES DUE TO BURNOUT CONDITIONS AND REPLACE FAULTY BALLASTS AS REQUIRED. INCLUDE IN BASE PRICE.
- REWORK EXISTING EMERGENCY LIGHTING TO ACHIEVE NEW EMERGENCY LIGHTING AS SHOWN. CONNECT NEW AND/OR RELOCATED LUMINAIRES TO NEAREST EMERGENCY LIGHTING CIRCUITS ON THIS FLOOR. PROVIDE 347-120V LIGHTING TRANSFORMERS AS REQUIRED. IF NEW EMERGENCY BRANCH CIRCUITS ARE REQUIRED FOR EMERGENCY LIGHTING AND EXISTING EMERGENCY LIGHTING PANEL IS LOCATED ON A DIFFERENT STOREY (i.e. NOT LOCATED ON SAME FLOOR), THEN NEW BRANCH CIRCUIT WIRING SHALL BE 2-HOUR FIRE RATED (i.e. MI CABLE) TO FIRST EMERGENCY LIGHT FED. IF EXISTING EMERGENCY LIGHTING PANEL IS LOCATED ON THE SAME STOREY, THE NEW BRANCH CIRCUIT WIRING DOES NOT NEED TO BE FIRE RATED. PROVIDE LOCK-ON BREAKERS TO SUIT.
- MEASURE THE ILLUMINATION OF THE FLOOR AT NIGHT WITH EMERGENCY LIGHTING ON ONLY, AND SEND A DRAWING SHOWING THE MAXIMUM AND MINIMUM LEVEL OF ILLUMINATION, TO THE CONSULTING ENGINEER FOR REVIEW. PROVIDE WRITTEN CONFIRMATION THAT EMERGENCY LIGHTING HAS BEEN INSTALLED IN ACCORDANCE WITH CONTRACT DOCUMENTS AND LATEST EDITION OF THE ONTARIO BUILDING CODE SECTIONS 3.2.7.3 AND 3.2.7.4. LETTER TO BE INCLUDED AS PART OF CLOSE-OUT DOCUMENT SUBMITTAL PACKAGE.
- PROVIDE NEW PICTOGRAM (RUNNING MAN) TYPE EXIT SIGNS. **FACES AND INDICATOR ARROWS AS PER DRAWINGS AND UNIVERSAL 120-347VAC VOLTAGE INPUT UNLESS OTHERWISE NOTED.** CONNECT NEW EXIT SIGNS TO THE NEAREST AVAILABLE SPARE EXIT LIGHTING CIRCUIT. DO NOT OVERLOAD THE CIRCUIT. ALLOW FOR **THREE (3)** ADDITIONAL EXIT SIGNS (COMPLETE WITH MATERIAL AND LABOUR) TO BE INSTALLED AS PER BUILDING INSPECTORS REQUIREMENTS UPON FINAL INSPECTION PER EACH AREA.
- LOCATE AND POSITION EXIT SIGNS SUCH THAT THEY DO NOT INTERFERE WITH ADJACENT EXIT SIGNS AND EMERGENCY LIGHTING COVERAGE.
- ALL MODIFICATIONS TO FIRE ALARM SYSTEM AND DEVICES TO BE COMPLETED BY BASE BUILDING FIRE ALARM CONTRACTOR AND VENDOR/MANUFACTURER. BASE BUILDING FIRE ALARM CONTRACTOR/VENDOR/MANUFACTURER IS RESPONSIBLE TO ENSURE THAT ALL ADDITIONAL COMPONENTS (MATERIAL, SOFTWARE, INCLUDING ANY LABOUR TO INSTALL OR MODIFY FIRE ALARM DEVICES) ARE INCLUDED FOR BASED ON ISSUED DRAWINGS. ELECTRICAL CONTRACTOR TO ALLOW FOR ALL ASSOCIATED COSTS. NEW FIRE ALARM **SPEAKER** ARE TO MATCH EXISTING AND BE CONNECTED TO NEAREST AVAILABLE SPARE EMERGENCY ZONE CIRCUIT(S). CONNECT NEW **SPEAKER** TO EXISTING CIRCUITS, WHERE THERE IS SPARE CAPACITY ON RESPECTIVE CIRCUITS. IF THERE IS NO CAPACITY ON EXISTING CIRCUITS, PROVIDE NEW FIRE ALARM CIRCUITS. ALLOW FOR ALL ASSOCIATED COSTS INCLUDING BUT NOT LIMITED TO: ASSOCIATED EQUIPMENT, DEVICES, PROGRAMMING, TESTING AND VERIFICATION TO MAKE SYSTEM OPERATIONAL AND CODE COMPLIANT. ALL FIRE ALARM VERIFICATION SHALL CONFORM TO CAN/ULC-SS37 LATEST EDITION. FIRE ALARM SYSTEM SHALL BE INSTALLED IN CONFORMANCE WITH CAN/ULC-SS24 LATEST EDITION.
- ENSURE THAT ALL LIGHTING FIXTURES ARE CLEAN AND ILLUMINATED BY END OF PROJECT.
- ENSURE EXISTING FIXTURES OUTSIDE OF THE SCOPE OF WORK FED FROM EXISTING CIRCUITS THAT ARE DISCONNECTED AS PART OF THE DEMOLITION SCOPE ARE RECONNECTED TO EXISTING LIGHTING CIRCUITS. CONTRACTOR TO PROVIDE ADDITIONAL CIRCUITS WHERE REQUIRED. NEW LOW VOLTAGE SWITCH ARRANGEMENT OF LIGHTING TO BE CO-ORDINATED WITH LANDLORD AND REARRANGED TO SUIT NEW LAYOUT. ALL LIGHTING, EXCLUDING EMERGENCY, WITHIN THE TENANT PREMISES TO BE ON A SEPARATE LIGHTING ZONE AND TO BE CONTROLLED BY BASE BUILDING LIGHTING CONTROL SYSTEM. PROVIDE ALL NECESSARY RELAYS, CONTACTORS, RELAY PANELS, AND DRY INTERFACES REQUIRED FOR SUCH CONTROL. INCLUDE COST IN THIS CONTRACT.
- LIGHTING FIXTURES IDENTIFIED AS EMERGENCY ARE TO BE CONNECTED SO THAT UNDER NORMAL CONDITIONS THEY WORK IN CONJUNCTION WITH THE SWITCHING AS IDENTIFIED. IN THE EVENT OF AN EMERGENCY, THESE LIGHTS ARE TO BE FORCED ON WITH THE USE OF A UL-924 LISTED RELAY. UPON POWER FAILURE THE RELAY IS TO ACTIVATE THE LIGHTS TO FULL BRIGHTNESS. REFER TO DETAIL **7/TE-0.6** FOR REQUIREMENTS.
- COORDINATE INSTALLATION OF FIXTURES WITH MECHANICAL EQUIPMENT, ELECTRICAL EQUIPMENT, SPRINKLERS AND DUCT WORK WITH OTHER TRADES PRIOR TO WORK COMMENCING.
- ALL CEILING MOUNTED OCCUPANCY SENSORS PROVIDED AS PART OF THIS SCOPE OF WORK MUST BE LOCATED AT LEAST 6"0" AWAY FROM ANY SUPPLY AIR DIFFUSER AND RETURN AIR GRILLE AS PER MANUFACTURER'S RECOMMENDATION. COORDINATE INSTALLATION ON SITE WITH MECHANICAL CONTRACTOR PRIOR TO COMMENCING WORK.
- FIRE ALARM TESTING CAN ONLY BE DONE BETWEEN THE HOURS OF 7AM AND 8AM. FIRE ALARM CONTRACTOR TO PLAN FOR THIS AND SCHEDULE SITE VISITS AS REQUIRED.
- IN ADDITION TO THE FIRE ALARM DEVICES INDICATED ON DRAWINGS, BASE BID PRICE SHALL INCLUDE FOR PROVISION (SUPPLY AND INSTALL) OF AN ADDITIONAL THREE (3) FIRE ALARM SPEAKER/STROBE FOR THIS FLOOR COMPLETE WITH 30'-0" CONDUIT AND WIRING (PER DEVICE), PROGRAMMING, TESTING AND CERTIFICATION, LABELING AND 100% REPEAT VERIFICATION FOR EACH DEVICE POST CITY FIRE DEPARTMENT INSPECTION.
- ONCE THE THERMOSTAT OVERRIDE BUTTON IS PRESSED, THE LIGHTING SYSTEM IS TO ACTIVATE THE HALLWAY LIGHTING. COORDINATE LOCATION OF THERMOSTAT WITH MECHANICAL.


DRAWING NOTES:

- (N-1) ALL FIXTURES ARE TYPE "L1" UNLESS OTHERWISE NOTED. TYP
(N-2) FINAL LOCATION OF POTLIGHTS TO BE COORDINATED ON-SITE. TYP

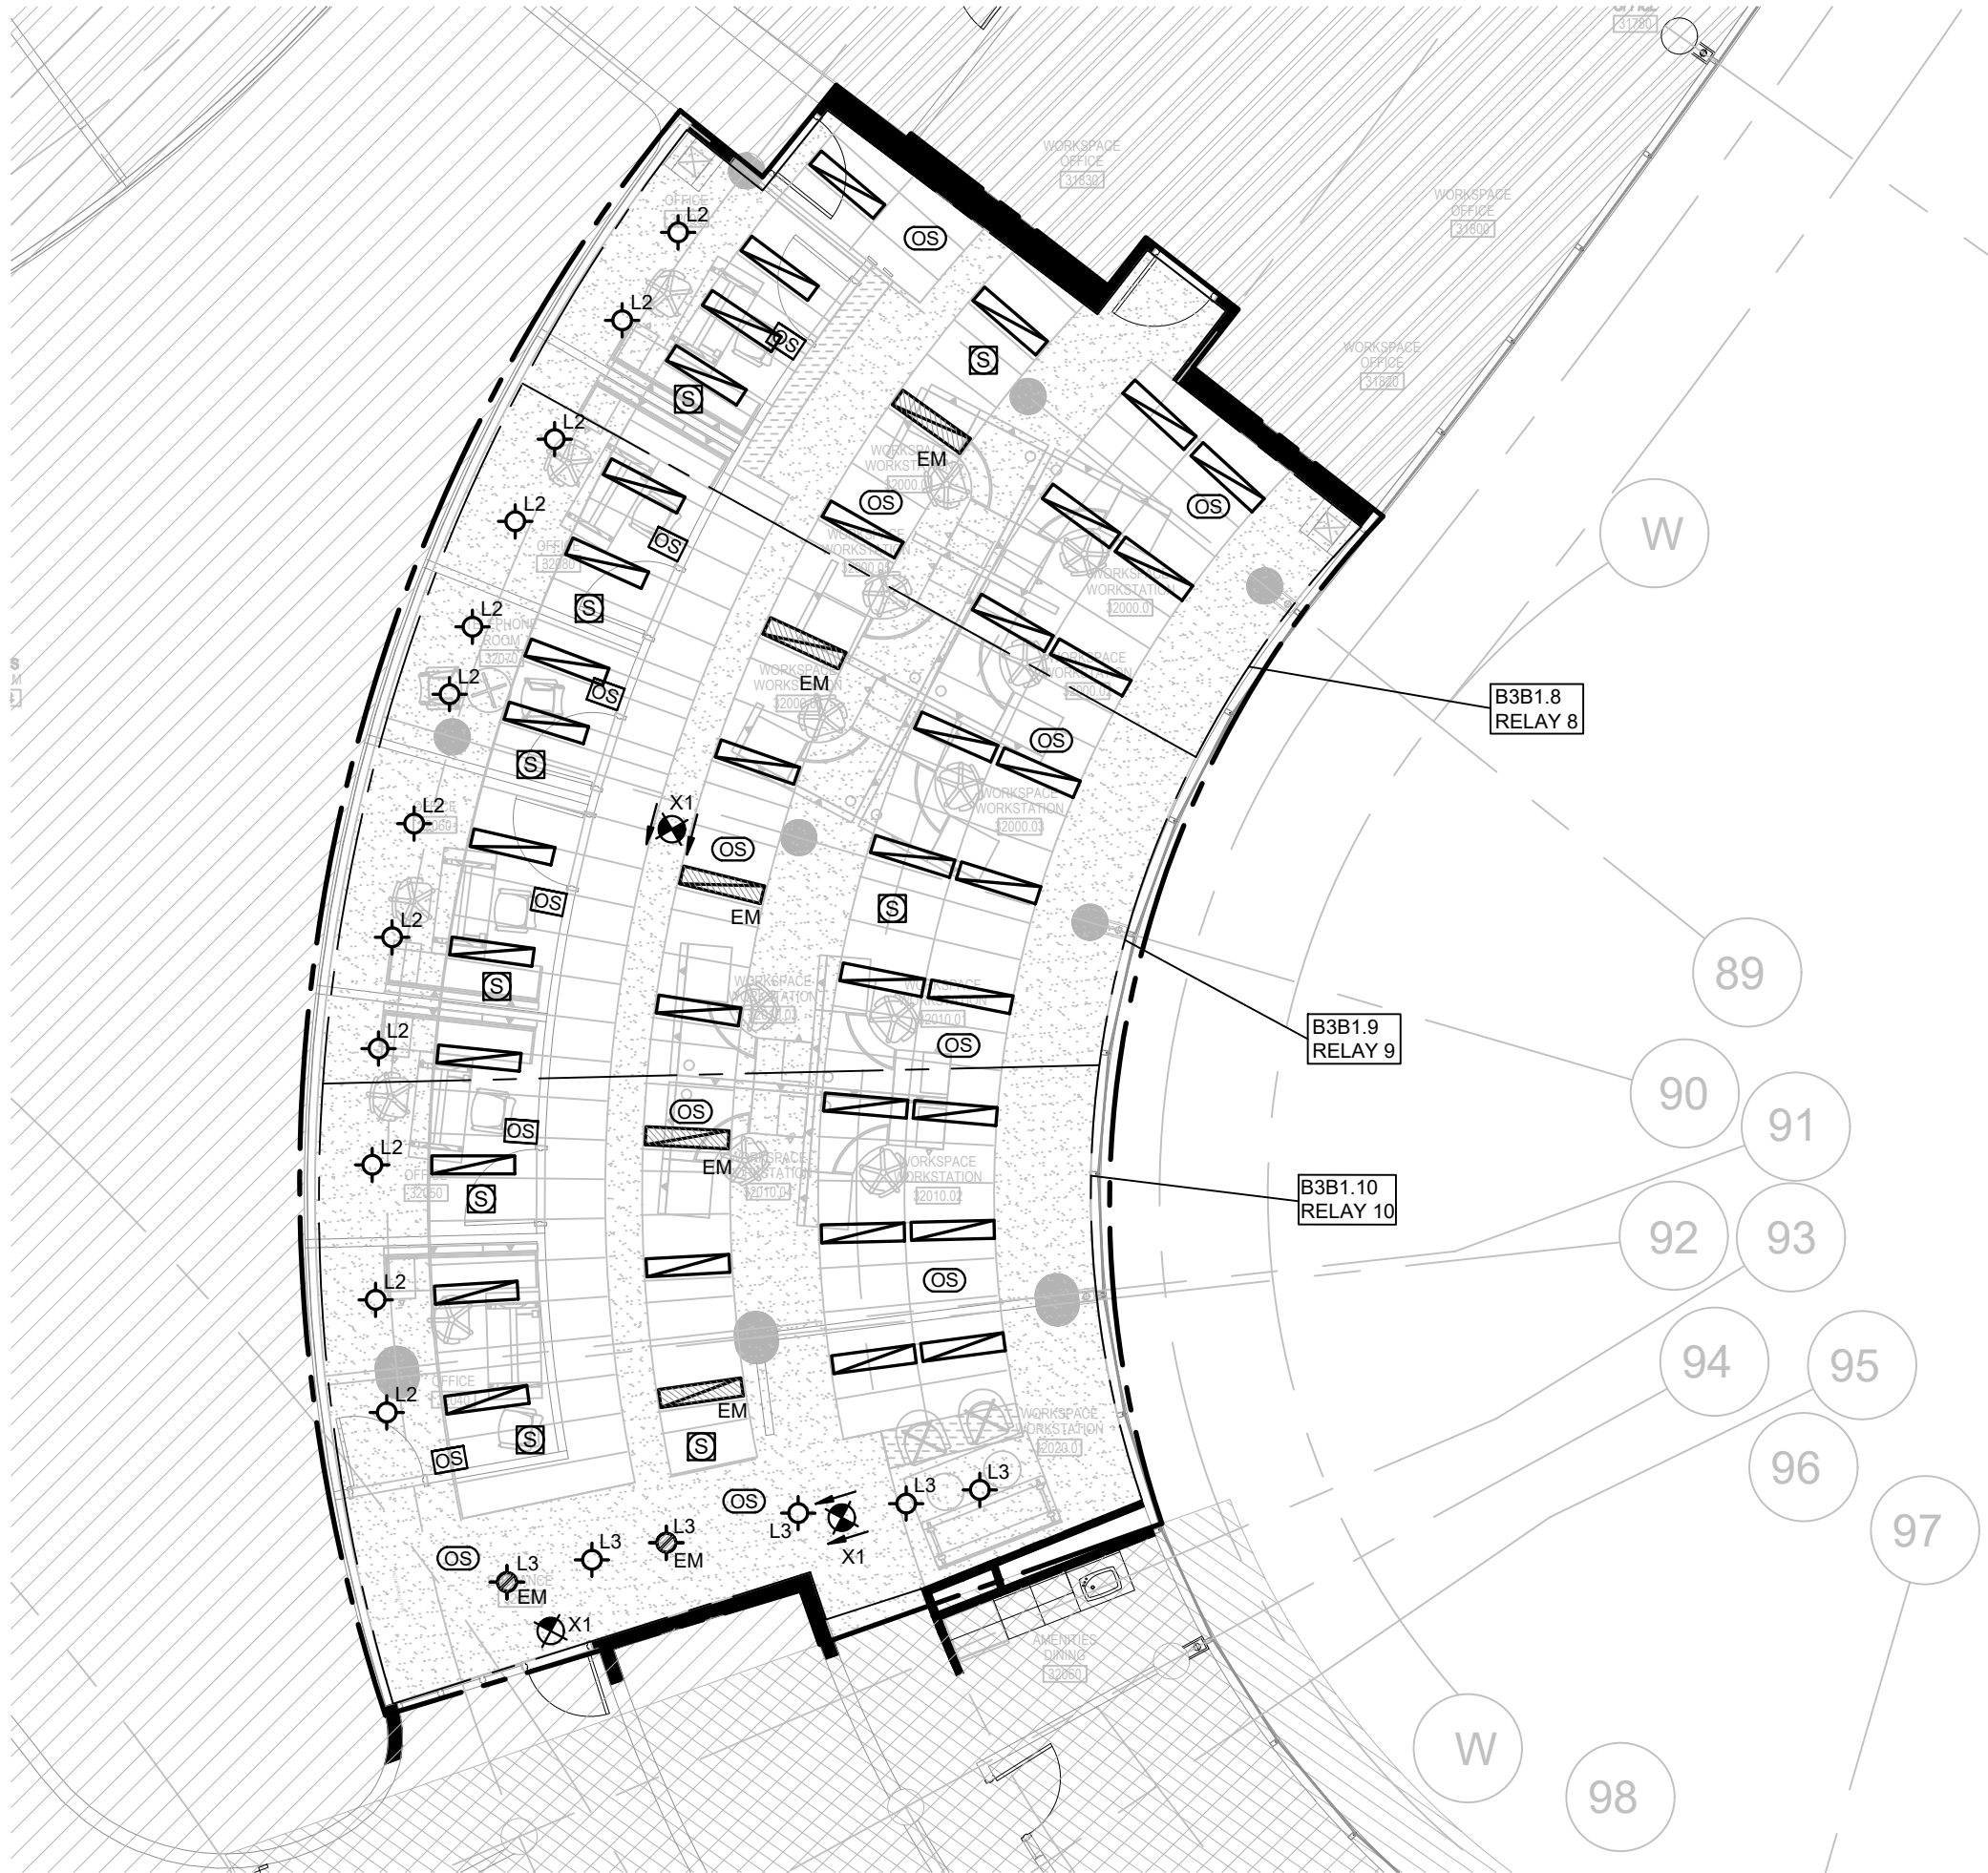

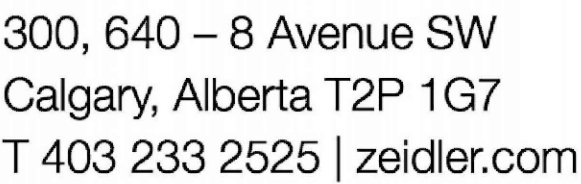

TE-3.2

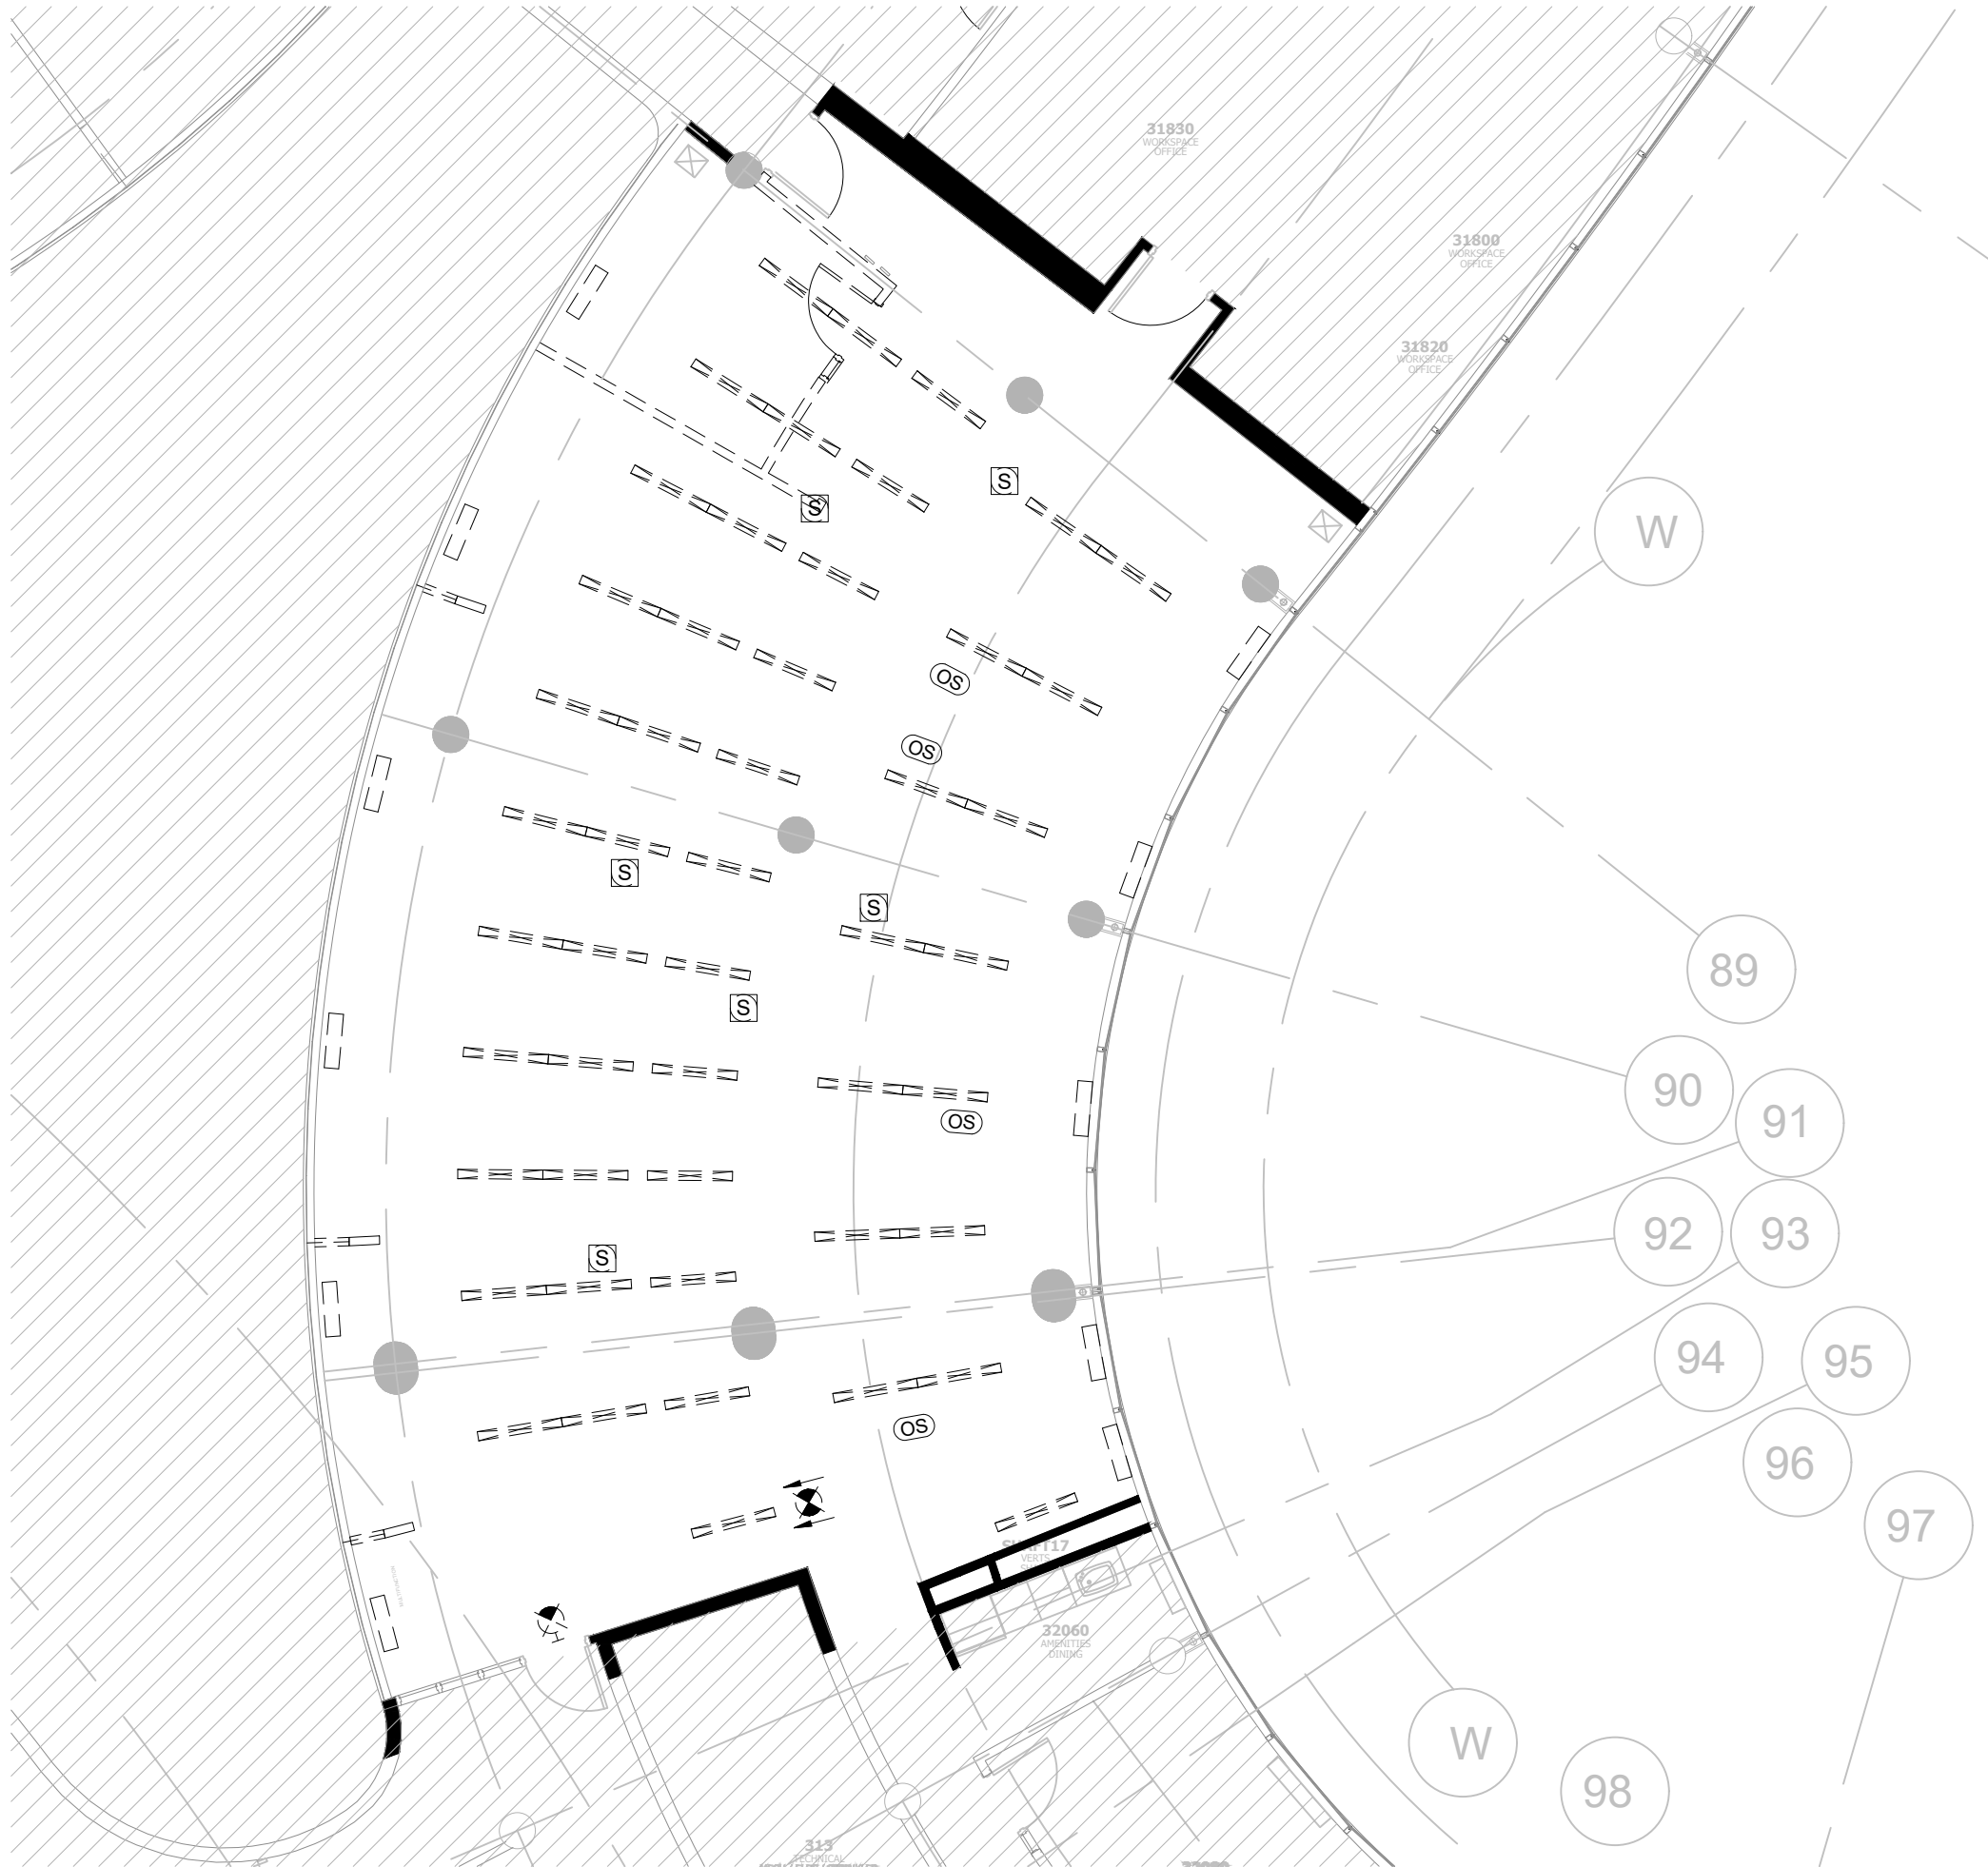

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PROJECT

**YORK REGION
MUNICIPALITY CENTRE**

PROJECT ADDRESS

17250 YONGE STREET, NEWMARKET, ONTARIO L3Y 4W5

TITLE

**PARTIAL THIRD FLOOR
LIGHTING & FIRE ALARM
DEMOLITION LAYOUT**

PROJECT NO. 14008-025-E
DRAWN JB
CHECKED WYC/NC

DRAWING NO. TE-3.3
SCALE 1:100

Zeidler Architecture


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DRAWING NOTES:

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PROJECT ADDRESS

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TITLE

PARTIAL THIRD FLOOR
POWER & SYSTEMS
DEMOLITION LAYOUT

PROJECT NO. 14008-025-E
DRAWN JB
CHECKED WYC/NC

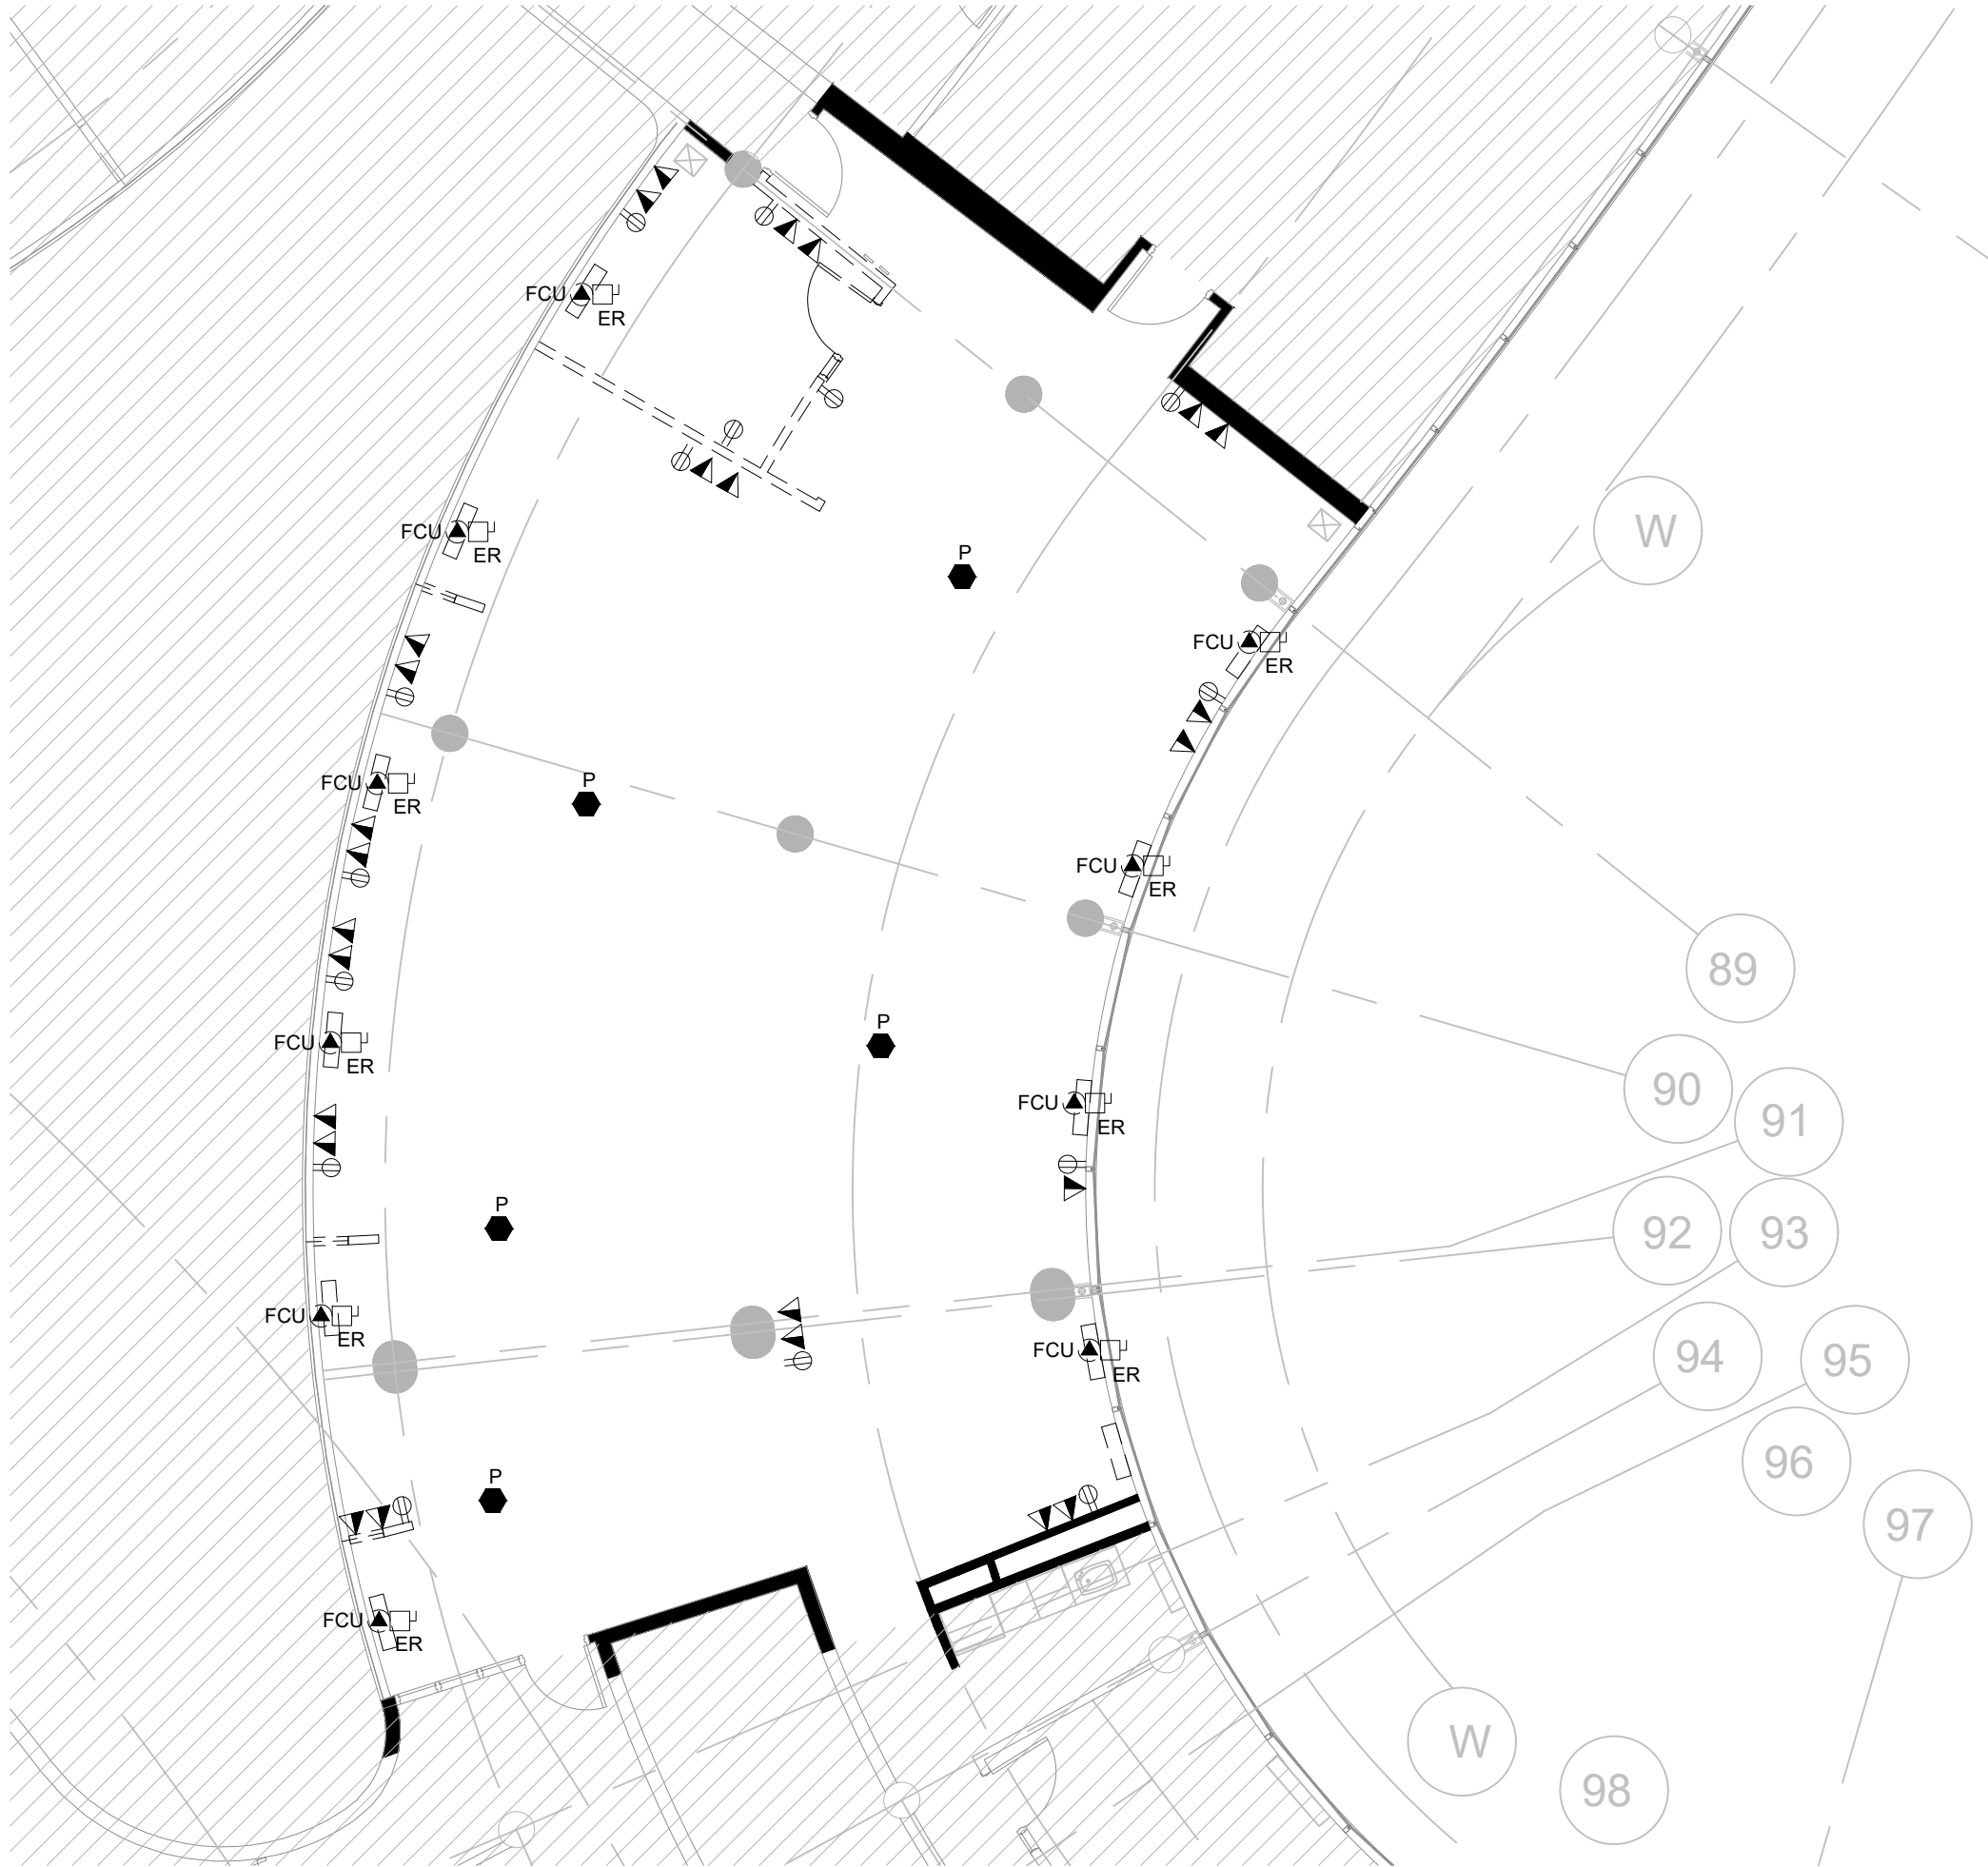DRAWING NO. TE-3.4
SCALE 1:100